

Notice of Meeting
Polk City | Planning and Zoning Commission (P&Z)

June 15, 2020 | 6:00 pm

Due to Covid-19 P&Z Commission will meet via ZOOM

Public Meeting participation is via phone only

Call in local 515-329-8019

Toll-Free 833-329-8019

Participant Code 593054

Public can also provide comments directly to support@polkcityia.gov

***any comments received before the time of the meeting will be made a part of the public hearing**

Tentative Meeting Agenda

Dennis Dietz | Chair

Krista Bowersox | Pro Tem

P&Z Commission Members: Ron Hankins | Deanna Triplett | Doug Ohlfest | Justin Vogel | Doug Sires

1. Call to Order
2. Roll Call
3. Approval of Agenda
4. Approval of P&Z Commission Meeting minutes for May 18, 2020
5. Consider recommendation to Council to re-approve the Final Plat for Deer Haven Plat 3
6. Kwik Star
 - a. Consider recommendation to Council to approve Kwik Trip #108 Preliminary Plat
 - b. Consider recommendation to Council to approve Kwik Trip #108 Final Plat
 - c. Consider recommendation to Council to approve Kwik Star Site Plan
7. Reports & Particulars
 - Council Liaison, City Manager, Staff, and Commission
8. Adjourn until July 20, 2020

MEETING MINUTES
The City of Polk City
Planning and Zoning Commission
6:00 p.m., Monday, May 18, 2020

Polk City, Planning and Zoning Commission (P&Z) held a meeting at 6:00 p.m., on May 18, 2020 via ZOOM. The Agenda was posted at the City Hall office as required by law. **These tentative minutes reflect all action taken at the meeting.**

1. **Call to Order** | Chair Dietz called the meeting to order at 6:00 p.m.
2. **Roll Call** | Hankins, Triplett, Bowersox, Dietz, Ohlfest, Vogel, Sires | In attendance via ZOOM
3. **Approval of Agenda**
MOTION: A motion was made by Ohlfest and seconded by Bowersox to approve the agenda.
MOTION CARRIED UNANIMOUSLY
4. **Audience | No comments**
5. **Approval of Meeting Minutes**
MOTION: A motion was made by Bowersox and seconded by Ohlfest to approve the April 20, 2020 meeting minutes.
YES: Ohlfest, Vogel, Sires, Hankins, Triplett, Bowersox
ABSTAIN: Dietz
MOTION CARRIED
6. **Zunkel Estates Plat 1**, Vic Piagentini, AEC Engineer for Zunkel Estates Plat 1 reported details on this plat within 2 miles of Polk City. All City Engineering comments were addressed.
 - a. **MOTION:** A motion was made by Ohlfest and seconded by Bowersox to recommend Council approval of the Preliminary Plat
MOTION CARRIED UNANIMOUSLY
 - b. **MOTION:** A motion was made by Ohlfest and seconded by Bowersox to recommend Council approval of the Final Plat
MOTION CARRIED UNANIMOUSLY
7. **Big Creek Technology Campus Plat 4**, Paul Claussen with CEC reported details on the Preliminary and Final Plat. Commission discussed zoning and trail easement.
 - a. **MOTION:** A motion was made by Hankins and Vogel by Bowersox to recommend Council approval of the Preliminary Plat subject to all engineering comments dated May 13, 2020 being satisfactorily addressed
MOTION CARRIED UNANIMOUSLY
 - b. **MOTION:** A motion was made by Hankins and seconded by Ohlfest to recommend Council approval of the Final Plat subject to all engineering comments dated May 14, 2020 being satisfactorily addressed
MOTION CARRIED UNANIMOUSLY
8. **P&M Apparel Site Plan**, Mark Thiessen, Angelo Architectural Associates LLC, on behalf of Kay Ferin, P&M Owner presented the Site Plan for a new building located at the SW corner of W Bridge Rd and 5th Street. Kathleen Connor, City Engineering Representative commented on provisions for a sidewalk easement, lighting plan and storm water discharge. Dan Southwick, Bishop Engineering responded. Hankins expressed his desire to limit sidewalk deferments as much as possible because of the Community

Visioning Committee focusing on eliminating gaps. He also requested P&M reconsider installation of a bike rack in their parking lot. Hankins shared his concern regarding the single pitch roof and Commission discussed their thoughts and also discussed traffic patterns.

MOTION: A motion was made by Hankins and seconded by Sires to recommend Council approval of the P&M Apparel Site Plan subject to the Engineering comments dated May 13, 2020 being satisfactorily addressed

MOTION CARRIED UNANIMOUSLY

- 10. Reports & Particulars** – Council Member Anderson reported hiccups at the Council meeting regarding the Snetselaar property, but he said he is confident it will be revisited at an upcoming Council meeting. Ohlfest asked for an update on HyVee and Kwik Star. City Manager Huisman said there was not an update to report on HyVee but Kwik Star has submitted plans and anticipates them moving forward at the June P&Z meeting.

11. Adjournment

MOTION: A motion was made by Ohlfest and seconded by Bowersox to adjourn at 6:44 p.m.

MOTION CARRIED UNANIMOUSLY

Next Meeting Date – Monday, June 15, 2020

Attest:

Jenny Gibbons - City Clerk

FINAL PLAT REVIEW

Date: June 8, 2020 Prepared by: Kathleen Connor
Project: Deer Haven Plat 3 Project No.: 116.1046

GENERAL INFORMATION:

Applicant: Deer Haven Land Company LLC
Request: Approval of Final Plat
Location: East of the original town
Size: 5.43 Acres
Zoning: R-2 (Lots 1-4)
Parcels: 4 Residential Lots in R-2 District
Lot A for a park



PROJECT BACKGROUND:

The Preliminary Plat for Deer Haven Plat 3 was approved by City Council on February 27, 2017. The Construction Drawing were approved on June 12, 2017. The Final Plat for Deer Haven Plat 3 was approved by the Planning & Zoning Commission on October 16, 2017 at the same meeting the Final Plats for Deer Haven Pat 1 and Plat 2 were approved.

Some of the public improvements associated with this plat, including the water main extension along E. Broadway and grading on the northwest portion of the plat, were completed in early 2018. The developer subsequently decided to put the project on hold due to a lack of buyers, so the remaining grading, tree removals and utility service lines were not installed. However, the developer recently completed the tree removals and grading and is now working on installing services.

Since the Final Plat and legal documents were not presented to City Council for approval in a timely fashion following P&Z's approval, the Commission's recommendation is considered null and void. Since construction is nearing completion, the developer now requests P&Z approval of the Final Plat and plans to submit the Final Plat and legal documents to City Council for approval within 60 days after the P&Z meeting.

PROJECT DESCPTION:

The public improvements associated with this plat includes water main extension, along with water services and sanitary sewer services constructed to serve lots within this plat. The existing 10' wide recreational trail on Lot A was constructed with the Deer Haven Plat 1 improvements. No changes were made to E Broadway paving, although the ditch was defined on the north side of the street.

The parkland dedication for Deer Haven Plats 1, 2 and 3 was met in part by the paving of a 10' recreational trail extending along E. Broadway, beginning at the developer's northwest property line just northwest of the cemetery, extending down E. Broadway, then crossing into Deer Haven on the north side of the street, then running across Outlot "X" and the rear yards of Lots 1-7 of Plat 1 to its point of termination at the Crossroads on the Lakes property line. The remainder of the parkland obligation includes dedication of Lot A to the City for use as a park.

REVIEW COMMENTS:

A. Final Plat.

All review comments were addressed on Submittal #3.

B. Legal Documents. Prior to City Council consideration of this Final Plat, all legal documents, shall be reviewed and approved by the City Attorney prior to this item being placed on the Council agenda. These documents include:

1. *Record of Lot Tie Agreements* permanently tying Outlot Y to Lot 3 and permanently tying Outlot Z to Lot 4.
2. *Easement documents* for all public and private easements, revised per the City Attorney's comments, and signed by the developer. These easements include:
 - a. Recreational Trail Easement
 - b. Ponding Easement
 - c. Buffer Easement
 - d. Public Utility Easement
3. *Permanent Site Separation Waiver Agreement and Easement* covering Lots 1-4 since all lots are located within 1,000 feet of the property line of the City of Polk City's property containing the equalization basins operated by the WRA.
4. *Sidewalk Performance Bond* covering installation of sidewalks on Lots 1-4 within three years of final plat approval.
5. *Platting legal documents* including Title Opinion, Consent to Plat, and Certificate of Treasurer.
6. *A Warrantee Deed* for dedication of Lot A along with Groundwater Hazard Statement.
7. *A contract* for installation of street lights, unless the street lights are in place prior to Council approval of the Final Plat.

B. Public Improvements Acceptance. Prior to Council approval of the Final Plat, the public improvements will need to be *accepted by City Council*. Construction will therefore need to be completed and all punch list items generated from the future walk-thru will need to be addressed. The developer's contractors will need to provide *four-year Maintenance bonds* for the public improvements prior to acceptance.

Street lights must either be installed or a copy of the signed *contract with MidAmerican Energy* covering installation of the underground electrical distribution system and streetlights must be provided prior to acceptance.

Prior to acceptance of the public improvements, the developer's engineer will need to provide as-built *Record Drawings*; including spot elevations in the roadside ditch at each property line, verification of the platform for the future recreational trail along Broadway, verification of the platform for the future trail along the east side of Lot 4, verification of the building pads were established, and verification of ditch grading along E. Broadway; all in accordance with the approved construction drawings. The *Land Surveyor's certification* will need to be provided stating that all property corners have been set. The Service Located table will need to be provided by the contractor dimensioning all service stubs from the nearest lot corner.

RECOMMENDATION:

Staff recommends P&Z approval of the Final Plat for Deer Haven Plat 3 subject to the following:

1. Prior City Council acceptance of the Public Improvements associated with this plat, including provision of 4-year Maintenance Bonds, signed contract with MidAmerican Energy, Record Drawings, Land Surveyor certification property corners are set, and service locates table.
2. Prior approval of all necessary legal documents by the City Attorney.
3. Payment in full to the City Clerk for all application, engineering review fees and reimbursement for street signs.

FINAL PLAT DEER HAVEN PLAT 3

OWNER/APPLICANT
DEER HAVEN LAND COMPANY LLC
1444 NW 124TH CT.
CLIVE, IA 50325
CHRIS DAWSON 515-210-7515
CDAWSON@PLATINUMDEVELOPMENT.COM

ZONING
R-2 (LOTS 1-4)

LAND USE
EXISTING: VACANT
PROPOSED: SINGLE FAMILY RESIDENTIAL

SETBACKS
FRONT - 30'
REAR - 35'
SIDE - 8'

LEGAL DESCRIPTION
A tract of land located in Lots 5 and 7 of the Official Plat of the Northwest Fractional 1/4 and the North 1/2 of the Southwest 1/4 and in the West 1/2 of the Northeast 1/4 all of which is in Section 1, Township 80 North, Range 25 West of the 5th P.M., Polk City, Polk County, Iowa. Said tract of land being more particularly described as follows:

Beginning at the Southeast Corner of said Lot 5, said point being on the Northerly Right-of-Way Line of E. Broadway Street as it is presently established; thence N51°30'07"W, 1303.31 feet along said Northerly Right-of-Way Line, to the Southwest Corner of said Lot 7; thence N38°29'53"E, 102.00 feet; thence S50°48'37"E, 640.00 feet; thence S83°42'18"E, 542.39 feet; thence S26°03'37"E, 235.25 feet; thence S49°06'11"W, 240.21 feet; thence S00°24'14"W, 58.85 feet to the Point of Beginning

Said tract of land subject to all easements of record.

Said tract of land contains 5.43 acres more or less.

LEGEND

—	PLAT BOUNDARY
▲	SECTION CORNER
●	FOUND CORNER, AS NOTED
○	SET CORNER 5/8" I.R. W/ YELLOW CAP #13156
I.R.	IRON ROD
G.P.	GAS PIPE
D.	DEEDED DISTANCE
M.	MEASURED DISTANCE
R.	PREVIOUSLY RECORDED DISTANCE
P.U.E.	PUBLIC UTILITY EASEMENT
3333	ADDRESS
B.S.L.	BUILDING SETBACK LINE
M.O.E.	MINIMUM OPENING ELEVATION
M.P.E.	MINIMUM PROTECTION ELEVATION
N.R.	NOT RADIAL

CERTIFICATION

I HEREBY CERTIFY THAT THIS LAND SURVEYING DOCUMENT WAS PREPARED AND THE RELATED SURVEY WORK WAS PERFORMED BY ME OR UNDER MY DIRECT PERSONAL SUPERVISION, AND THAT I AM A DULY LICENSED PROFESSIONAL LAND SURVEYOR UNDER THE LAWS OF THE STATE OF IOWA.

KEVEN J. CRAWFORD, PLS. IOWA LICENSE NO. 13156
MY LICENSE RENEWAL DATE IS DECEMBER 31, 2018
PAGES OR SHEETS COVERED BY THIS SEAL:
This sheet only

COOPER CRAWFORD & ASSOCIATES, L.L.C.
CIVIL ENGINEERS

475 S. 50th STREET, SUITE 800, WEST DES MOINES, IOWA 50265
PHONE: (515) 224-1344 FAX: (515) 224-1345

DATE: 9-29-2017
REVISIONS: 10-16-2017
06-04-2017
06-08-2017


DATE: 9-29-2017
REVISIONS: 10-16-2017
06-04-2017
06-08-2017

APPROVED: --- INITIALS: --- AS-BUILT: ---

**FINAL PLAT
DEER HAVEN PLAT 3**

**CC
1843**

**SHEET
1 OF 1**

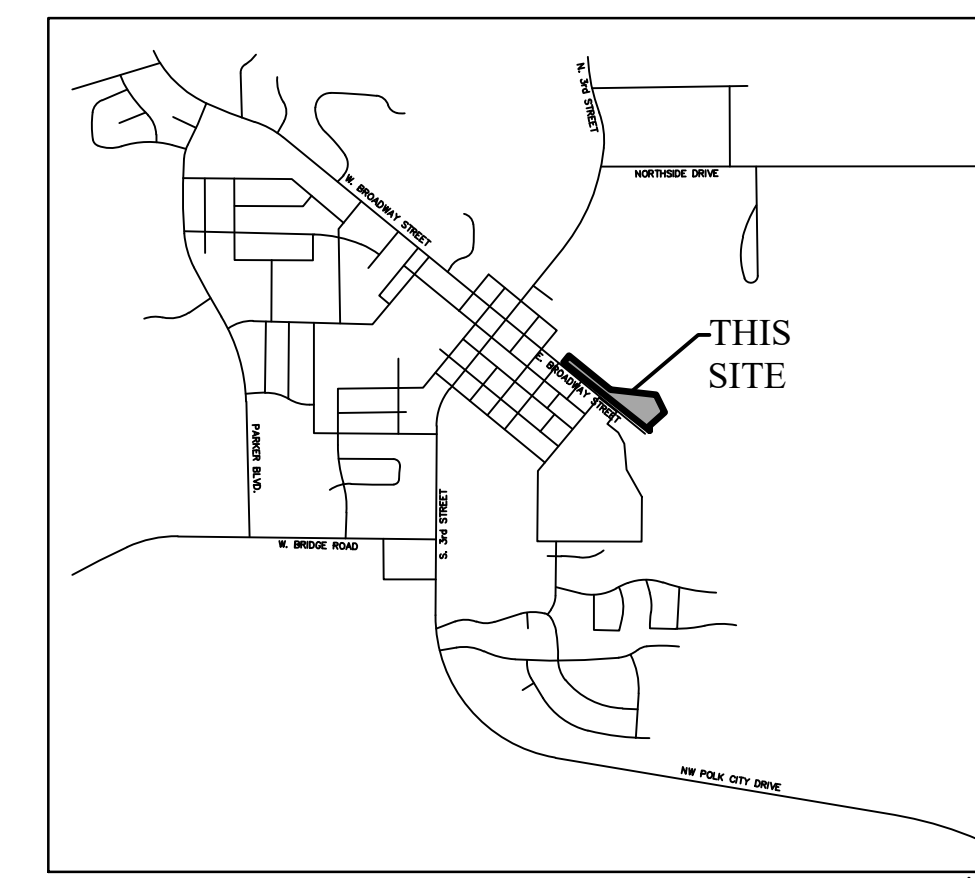

VICINITY SKETCH



SURVEYORS NOTES


1. LOT CORNERS SHALL BE SET PRIOR TO COUNCIL ACCEPTANCE OF THE PUBLIC IMPROVEMENTS.
2. THIS PLAT BOUNDARY HAS AN ERROR OF CLOSURE OF LESS THAN 1 IN 10,000.
3. EACH LOT IN THIS PLAT HAS AN ERROR OF CLOSURE OF LESS THAN 1 IN 5,000.
4. BEARINGS BASED ON AN ASSUMED BEARING.
5. ELEVATIONS BASED OFF NAVD88 DATUM

MINIMUM BASEMENT ELEVATIONS

LOT #	M.B.E. - NAVD88
1	861.17
2	858.18
3	854.15
4	853.72

NOTES

1. LOT 'A' TO BE DEEDED TO THE CITY OF POLK CITY FOR A CITY PARK.
2. OUTLOTS 'Y' AND 'Z' TO BE DEEDED TO LOTS 3 AND 4 RESPECTIVELY.
3. DECKS WILL NOT BE ALLOWED TO ENCRUGH INTO EASEMENTS.
4. HOME BUILDER AND PLUMBING CONTRACTOR SHALL VERIFY SANITARY SERVICE STUB-OUT ELEVATIONS PRIOR TO HOUSE CONSTRUCTION TO ENSURE BASEMENT FLOOR ELEVATIONS WILL PROVIDE ADEQUATE FALL IN SERVICE PIPE (2% MINIMUM).
5. A CULVERT SHALL BE REQUIRED FOR EACH DRIVEWAY, SIZED IN ACCORDANCE WITH THE CONSTRUCTION DRAWINGS AND APPROVED BY THE PUBLIC WORKS DIRECTOR.
6. EACH LOT SHALL BE ALLOWED ONLY ONE DRIVEWAY ONTO THE PUBLIC STREET.
7. ALL NEW DRIVEWAYS WILL BE PAVED.
8. NO PRINCIPAL STRUCTURES, ACCESSORY STRUCTURES, OR DRIVEWAYS SHALL BE PERMITTED IN THE 35' BUFFER EASEMENT, HOWEVER RECREATIONAL TRAILS ARE PERMITTED WITHIN SAID BUFFER EASEMENT.
9. ROOF DRAINS OR SUBDRAINS SHALL NOT BE PERMITTED WITHIN THE 35' BUFFER EASEMENTS ADJACENT TO USACE PROPERTY.
10. THE MINIMUM BASEMENT ELEVATION (M.B.E.) SHALL BE THE ELEVATION OF THE LOWEST FLOOR, INCLUDING BASEMENT.
11. AN ELEVATION CERTIFICATE WILL NEED TO BE PROVIDED TO THE CITY PRIOR TO ISSUANCE OF A CERTIFICATE OF OCCUPANCY ON ALL LOTS WITH A DESIGNATED M.B.E. TO DEMONSTRATE PROTECTION ELEVATION REQUIREMENTS HAVE BEEN MET.
12. A PETITION & WAIVER SHALL BE PROVIDED FOR POTENTIAL FUTURE CONSTRUCTION OF EITHER A 4-FT WIDE SIDEWALK OR 4-FT OF A 10-FT WIDE RECREATIONAL TRAIL IN FRONT OF EACH LOT PRIOR TO ISSUANCE OF A CERTIFICATE OF OCCUPANCY ON LOTS 1-4.
13. THE CITY SHALL HAVE THE RIGHT, BUT NOT THE OBLIGATION, TO REMOVE DRAINAGE OBSTRUCTION FROM PONDING EASEMENT AREAS.
14. THE PROPERTY OWNER SHALL BE RESPONSIBLE FOR MAINTENANCE OF ALL EMBANKMENTS, INCLUDING REPAIR OF ANY DAMAGE DUE TO EROSION, WITHIN ALL EASEMENTS AND PRIVATE YARDS.
15. FOUNDATIONS FOR DWELLINGS ON LOTS 1-4 SHALL BE DESIGNED AND CERTIFIED BY A GEOTECHNICAL OR STRUCTURAL ENGINEER PRIOR TO ISSUANCE OF A BUILDING PERMIT FOR LOTS UNLESS ALLENDER-BUTZKE PROVIDES DOCUMENTATION THAT IT IS NOT NECESSARY.
16. NO LOT WITHIN THIS PLAT SHALL BE PERMITTED TO HAVE AN INDIVIDUAL MAILBOX.
17. THE ADJACENT PROPERTY OWNER SHALL BE RESPONSIBLE FOR SNOW REMOVAL AND SIDEWALK REPAIR AT EACH CLUSTER MAILBOX.
18. 4-FOOT WIDE SIDEWALKS SHALL BE INSTALLED ON LOTS 1-4 WITH THE BUILDING PERMITS FOR EACH LOT. THE EDGE OF THE SIDEWALK CLOSEST TO THE STREET SHALL BE 7 FEET FROM THE RIGHT-OF-WAY LINE AND THE EDGE OF THE SIDEWALK CLOSEST TO THE DWELLING SHALL BE 11 FEET FROM THE RIGHT-OF-WAY LINE.
19. DRIVEWAYS FOR LOTS 1-4 SHALL BE DESIGNED AND CONSTRUCTED WITH ADA-COMPLIANT CROSS SLOPE TO ACCOMMODATE A 10-FOOT WIDE RECREATIONAL TRAIL WITHIN THE 15' RECREATIONAL TRAIL EASEMENT. THE EDGE OF THE TRAIL CLOSEST TO THE STREET SHALL BE 1 FOOT FROM THE RIGHT OF WAY LINE AND THE EDGE OF THE TRAIL CLOSEST TO THE DWELLING SHALL BE 11 FEET FROM THE RIGHT-OF-WAY LINE.

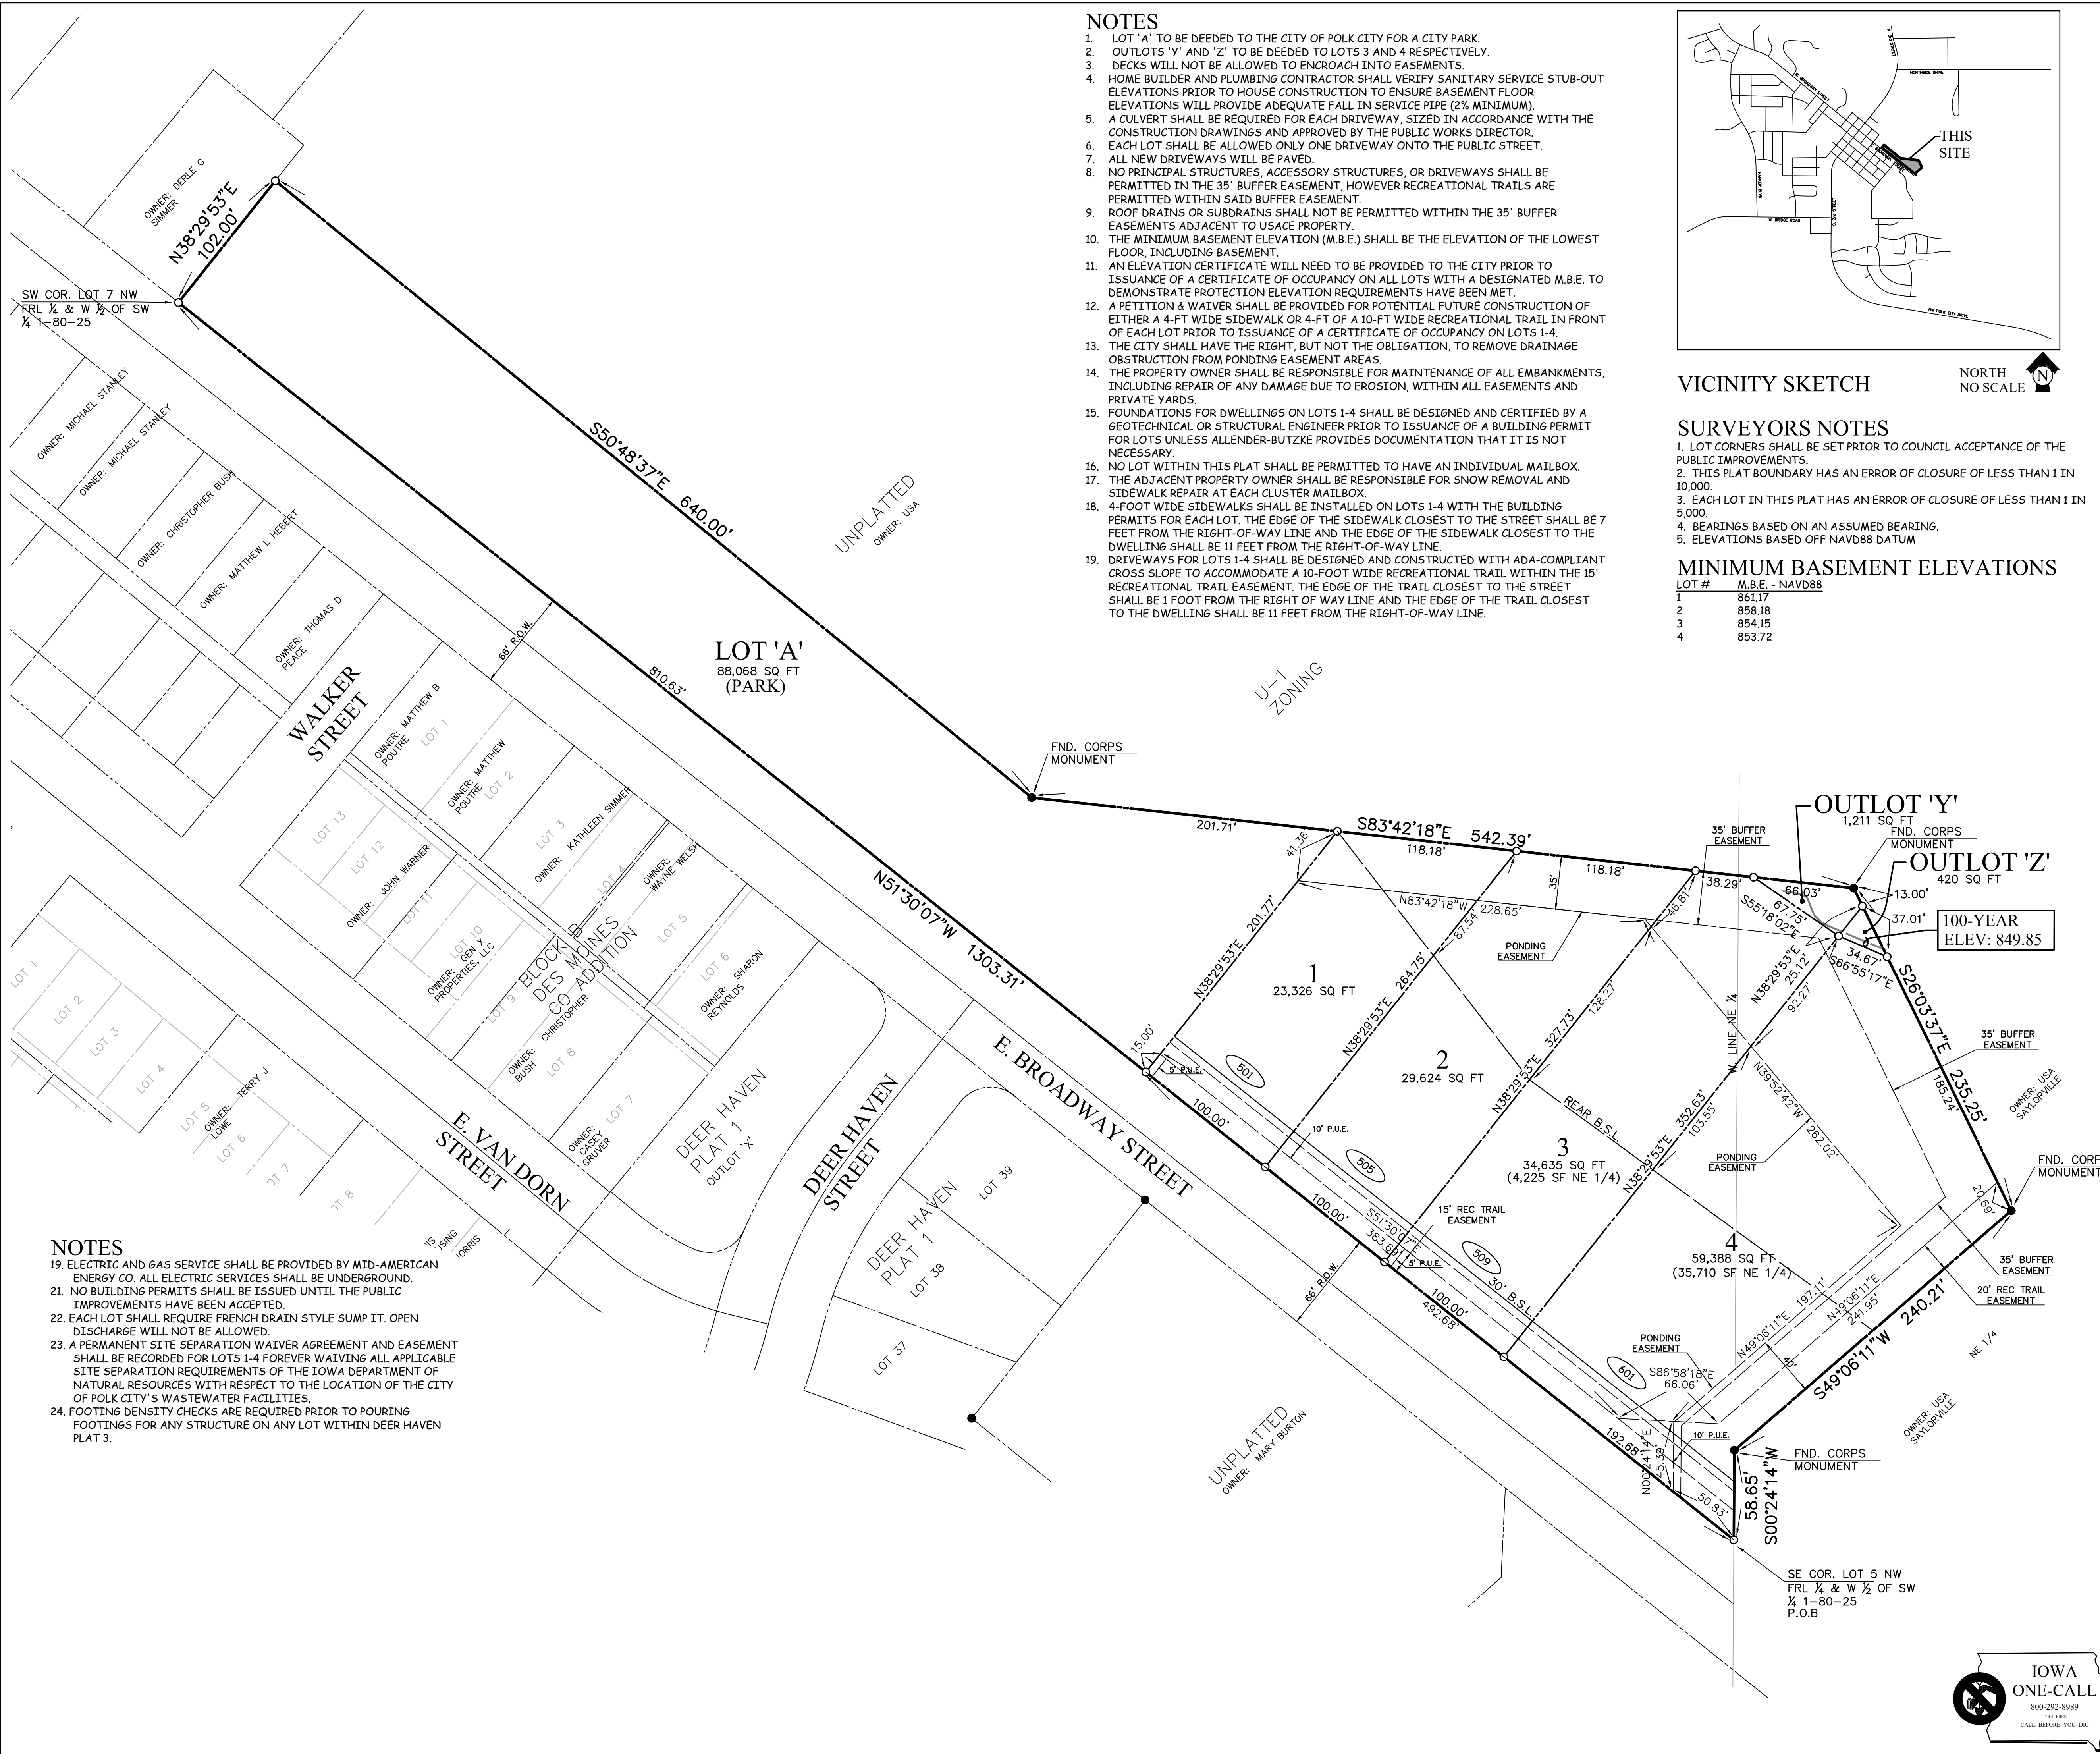

NOTES

19. ELECTRIC AND GAS SERVICE SHALL BE PROVIDED BY MID-AMERICAN ENERGY CO. ALL ELECTRIC SERVICES SHALL BE UNDERGROUND.
20. NO BUILDING PERMITS SHALL BE ISSUED UNTIL THE PUBLIC IMPROVEMENTS HAVE BEEN ACCEPTED.
21. EACH LOT SHALL REQUIRE FRENCH DRAIN STYLE SUMP IT. OPEN DISCHARGE WILL NOT BE ALLOWED.
22. A PERMANENT SITE SEPARATION WAIVER AGREEMENT AND EASEMENT SHALL BE RECORDED FOR LOTS 1-4 FOREVER WAIVING ALL APPLICABLE SITE SEPARATION REQUIREMENTS OF THE IOWA DEPARTMENT OF NATURAL RESOURCES WITH RESPECT TO THE LOCATION OF THE CITY OF POLK CITY'S WASTEWATER FACILITIES.
23. FOOTING DENSITY CHECKS ARE REQUIRED PRIOR TO POURING FOOTINGS FOR ANY STRUCTURE ON ANY LOT WITHIN DEER HAVEN PLAT 3.






PRELIMINARY PLAT REVIEW

Date: June 9, 2020
Project: Kwik Trip 1089

Compiled by: Kathleen Connor, Planner
Project No.: 119.0816.01

GENERAL INFORMATION:

Applicant:	Kwik Trip, Inc.
Property Owner:	Polk City Venture, LLC
Requested Action:	Approval of Preliminary Plat
Location	Lot 1 of "Polk City Venture Plat 1"
Size:	4.41 acres
Zoning:	C-2
Proposed Use:	Convenience Store with Car Wash

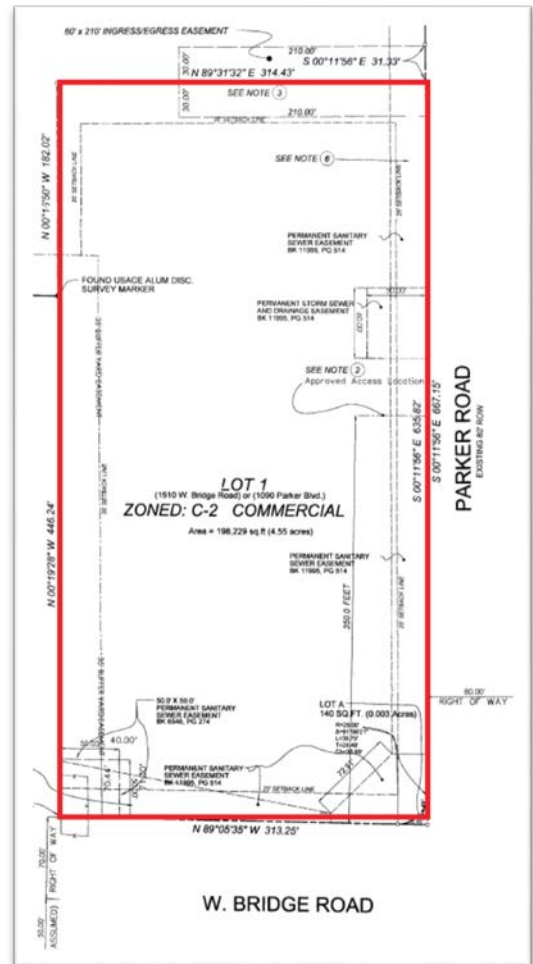

BACKGROUND:

City Council approved the Final Plat for Polk City Venture in December of 2013. This two-lot plat subdivided the C-2 commercial property from the R-3 residential property for marketing purposes. The residential property was subsequently developed as Bridgeview Plat 1.

The 2013 Final Plat, as approved, placed certain restrictions on this property that impact commercial development, including:

- Access on Parker Blvd. is restricted to an approved location 350 feet north of W. Bridge Road.
- Parker Boulevard was constructed to accommodate dual left-turn lanes; with southbound left turns onto W. Bridge Road and northbound left turns into this lot. However, it is currently used only as a long southbound turn lane. Re-stripping of this turning lane, including gore striping to the north would need to be completed as a Site Plan improvement.
- Joint access will be permitted to this lot at the lift station's existing driveway on W. Bridge Road, provided the developer paves this access as a site plan improvement. It is further noted that this access will be right-in/right-out only access.

DESCRIPTION:

Kwik Trip is now planning to construct a new Kwik Star convenience store on this property. The developer's original intention was to subdivide this property into two lots, with the south lot developed with a Kwik Star and north lot reserved for future development by others. The developer's revised

concept calls for the Kwik Star to develop the entire property as one lot. Due the need for public improvements and easements associated with this development, the developer plans to plat the property prior to site plan approval.

The proposed public improvements associated with this plat include the following:

- A. **Traffic Signal.** The Traffic Impact Study recommends installation of a traffic signal at the intersection of W. Bridge Road at Parker Blvd. the year Kwik Star opens. The design, construction, and Iowa DOT approval of this traffic signal will be the developer's responsibility in accordance with a Development Agreement as approved by City Council.
- B. **Parker Blvd Improvements.** The south right-in/right out access on Parker Blvd necessitates a 4-foot wide median on Parker Blvd to ensure there are no northbound left turns into the Kwik Star site from Parker Blvd. Additional improvements on Parker Blvd. include pavement widening to accommodate the median, pavement markings including crosswalk, and ADA-compliant ramps on both sides of the intersection, and reconstruction of the 4' sidewalk along Parker Blvd.
- C. **W. Bridge Road Improvements.** A westbound, right-turn lane will need to be provided at the proposed entrance on W. Bridge Road. Additional improvements include a median on W. Bridge Road to restrict eastbound left turns into the Kwik Star site, pavement markings, and a 10' wide recreational trail along the frontage of the property.
- D. **Edgewater Drive Improvements.** Since this development will not utilize the driveway approach from Edgewater Drive, this approach will need to be replaced with a long sweep curb.
- E. **Storm Sewers.** A public storm sewer will be constructed to convey runoff from the existing culvert beneath Parker Blvd to the west property line. A second public storm sewer will encapsulate the ditch on the north side of W. Bridge Road.

REVIEW COMMENTS:

Pursuant to review of Submittal #3 by City staff including City Engineer, we offer the following:


1. The narrative information will need to include the anticipated development schedule with start and completion dates for the construction of all public improvements.

RECOMMENDATION:

Based on the satisfactory resolution of each of the foregoing review comments, staff recommends P&Z approval of the Preliminary Plat for Kwik Trip 1089, subject to the following:

1. All staff review comments and P&Z recommendations, if any, shall be satisfactorily addressed prior to this Preliminary Plat being placed on the Council agenda for consideration.
2. Payment in full of all fees to the City Clerk.

VICINITY MAP

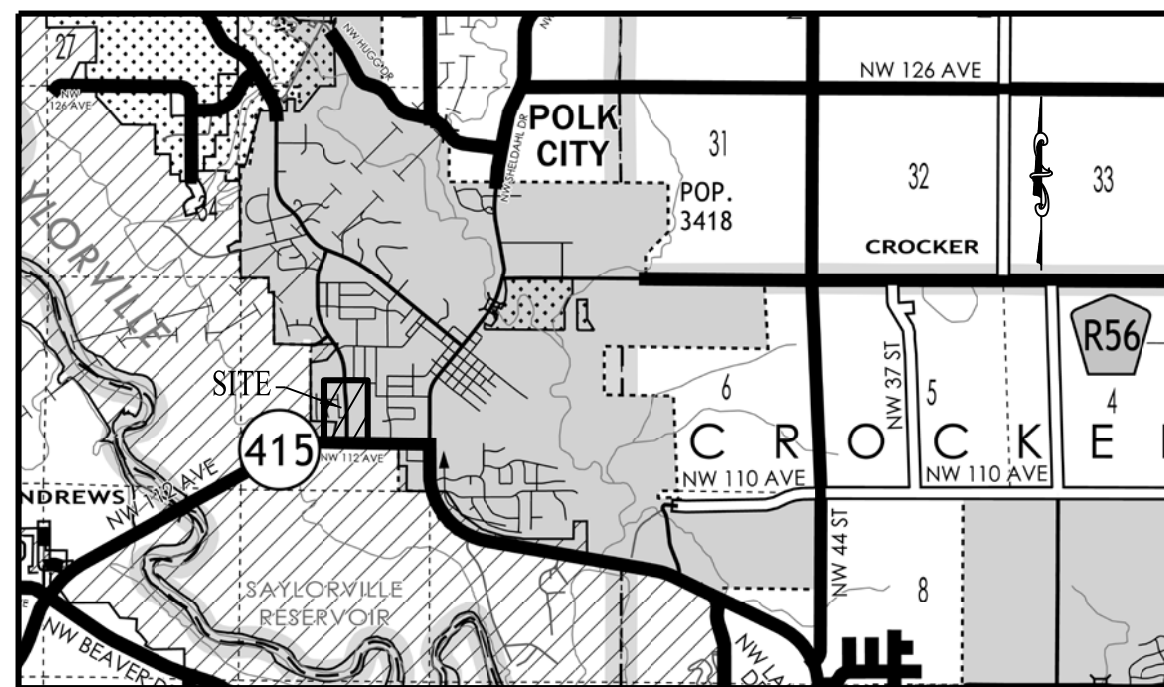

LEGEND

- Legend symbols for found section corners, utility poles, fences, and various lines.

0' 1 Mi. SCALE: 1" = 1 MILE

KWIK TRIP 1089 PRELIMINARY PLAT

LEGAL DESCRIPTION:

ALL OF LOT 1 IN POLK CITY VENTURE, AN OFFICIAL PLAT, EXCEPT LOT 'B' OF BRIDGEVIEW PLAT 1, AN OFFICIAL PLAT, ALL NOW INCLUDED IN AND FORMING A PART OF THE CITY OF POLK CITY, POLK COUNTY, IOWA.

BENCHMARK DATA:

BURY BOLT ON HYDRANT APPROX. 2' EAST OF SIDEWALK ON THE EAST SIDE OF PARKER BLVD. EAST SIDE OF PROPOSED SITE. NAVD88 ELEVATION=908.39 IOWA STATE PLANE SOUTH COORDINATE SYSTEM N=7,552,177.01 E=18,497,647.87

INDEX LEGEND


COUNTY: POLK LOCATION: PART OF LOT 1 IN POLK CITY VENTURE, POLK CITY SEC. 02, T29N, R25W... DATE OF SURVEY: 08-01-2019 THRU 08-23-2019

SITE INFORMATION

OWNER: POLK CITY VENTURE LLC 707 SKOKIE BLVD, STE 190 NORTHBROOK, IL 60062-2857... SUBMITTAL DATES: 1st SUBMITTAL: 08-26-2019

NOTES:

- 1. CONSTRUCTION SCHEDULE TO BEGIN WORK IN SPRING OF 2021. 2. DEVELOPER WILL BE RESPONSIBLE FOR A TEMPORARY TRAFFIC SIGNAL AT THE INTERSECTION OF W. BRIDGE RD. AT PARK BLVD. UNTIL A PERMANENT TRAFFIC SIGNAL CAN BE INSTALLED.

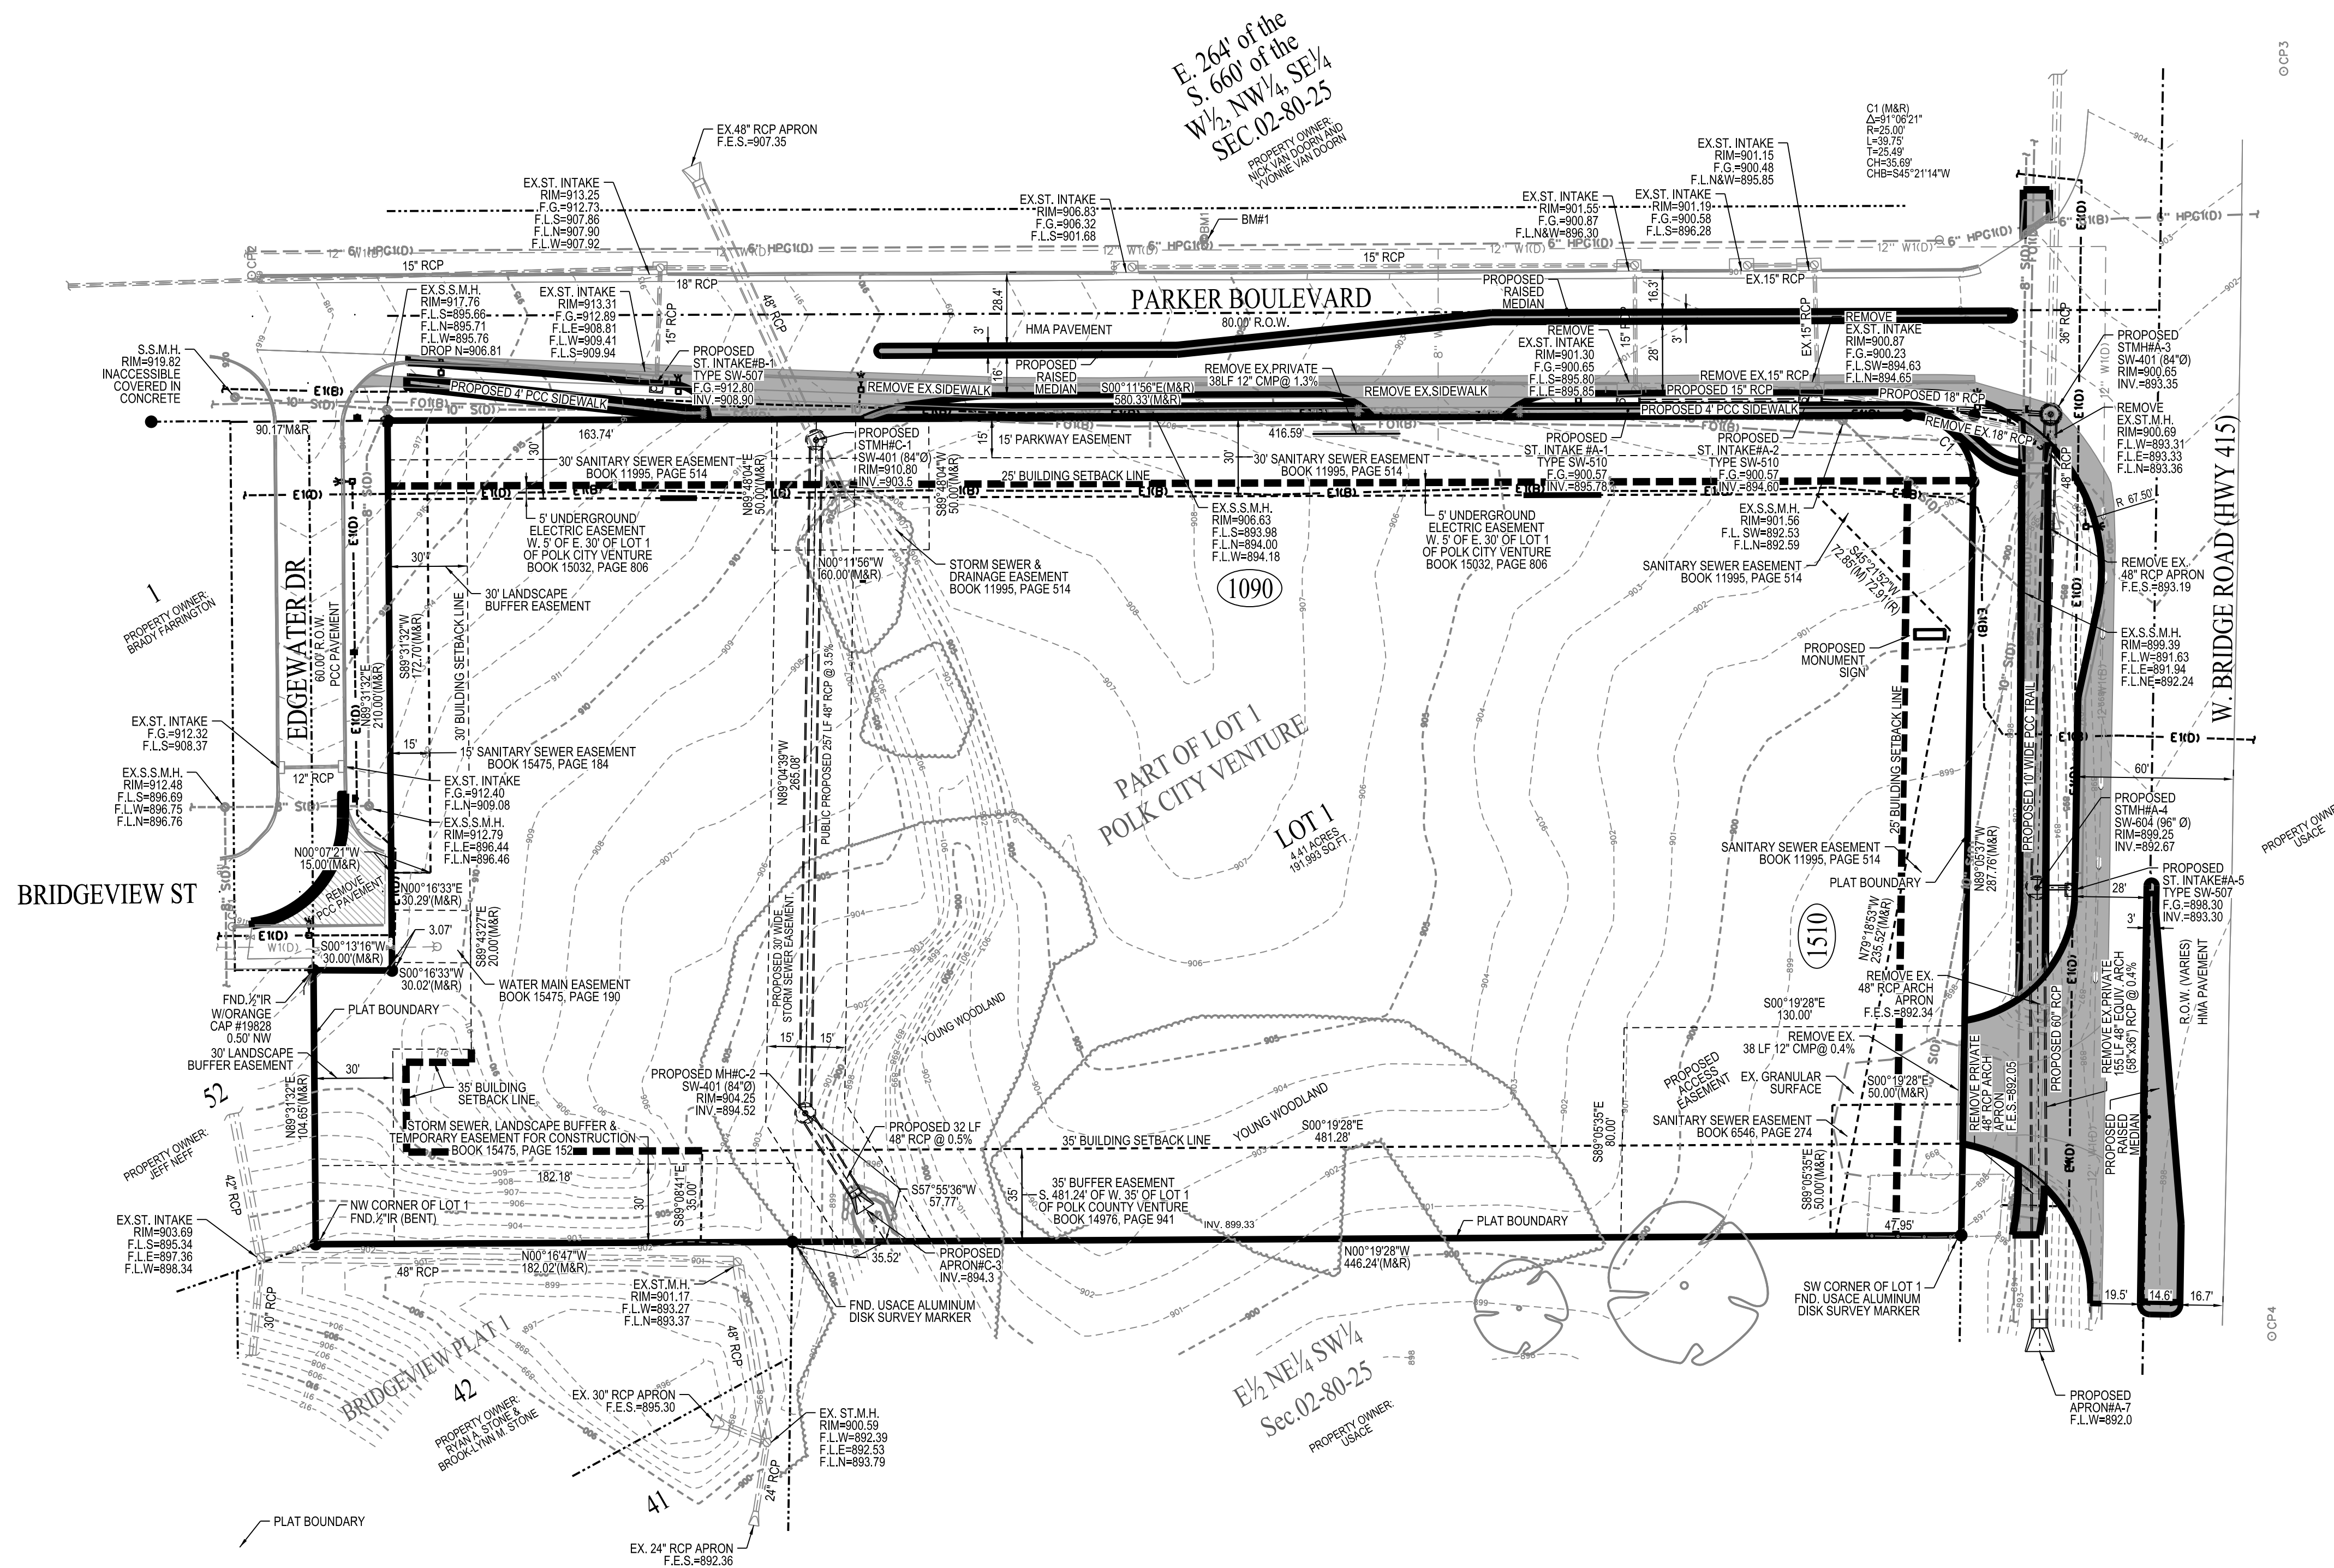

TLS THOMAS LAND SURVEYING, LLC logo and contact information.

Professional Land Surveyor seal for Matthew J. Thomas, License No. 19968.

I hereby certify that this land surveying document was prepared and the related survey work was performed by me or under my direct personal supervision... Date: 06-08-2020

Table with project details: PROJECT NUMBER 19085, COUNTY POLK, DATE DRAWN 06-08-2020, YEAR 2020, SHEET NO. 1.



FINAL PLAT REVIEW

Date: June 9, 2020
Project: Kwik Trip 1089

Compiled by: Kathleen Connor, Planner
Project No.: 119.0816.01

GENERAL INFORMATION:

Applicant: Kwik Trip, Inc.
Request: Approval of Final Plat
Location: Lot 1 of Polk City Venture Plat 1
Size: 4.41 acres
Zoning: C-2



DESCRIPTION:

Kwik Trip is now planning to construct a new Kwik Star convenience store on the subject property. Due to the need for public improvements and easements associated with this development, the developer plans to plat the property prior to site plan approval.

The developer has submitted the Preliminary Plat, Construction Drawings for Public Improvements, and Final Plat for this property. The Preliminary Plat and Construction Drawings for Public Improvements will need to be approved prior to, or concurrently with, the Final Plat. The related Site Plan for Kwik Star will be presented to Council approval after the Final Plat has been approved.

FINAL PLAT REVIEW COMMENTS:

A. **Final Plat.** Based on our review of Submittal #3, we offer the following comments:

1. Provide legal descriptions for all proposed easements for review prior to this item being placed on the Council agenda. These descriptions will need to be attached to the respective easement document for review by the City Attorney.

B. **Legal Documents.** All legal documents, shall be provided for review and approval by the City Attorney prior to this item being placed on the Council agenda. These documents include:

1. *Development Agreement* regarding the terms for splitting the cost of the traffic signal and potentially some additional offsite trails.
2. *Easement documents* for proposed easements shown on the Final Plat, revised per the City Attorney's comments, as follows:
 - a. 30' Public Storm Sewer Easement
 - b. 30' Landscape Buffer Easement.
 - c. 15' Parkway Easement

d. Lift Station Access Easement

3. *Subdivision Bond* covering the cost of all public improvements, including traffic signal.
4. *Platting legal documents* including but not limited to Title Opinion, Consent to Plat, and Certificate of Treasurer.

C. **Public Improvements Acceptance.** It is our understanding the developer would like to proceed with Final Plat approval at this time in order to move forward with Site Plan approval. Since construction of the required public improvements are expected to be completed concurrently with the construction of the private site plan improvements, the developer will need to provide a Subdivision Bond covering the cost of the public improvements depicted on the construction drawings.

The public improvements shall be completed prior to a Certificate of Occupancy being issued for the convenience store. Prior to City Council acceptance of these public improvements, construction will need to be completed and all punch list items generated from the future walk-thru will need to be addressed.

The developer should be aware that the public improvements require construction observation by the City Engineer. The developer will be responsible for fees associated with this service. In addition, the developer's contractors will need to provide four-year *Maintenance bonds* for the public improvements prior to City Council acceptance. The developer's engineer will need to provide as-built Record Drawings prior to acceptance.

RECOMMENDATION:

Based on the satisfactory resolution of the foregoing review comments, staff recommend P&Z approval of the Final Plat for Kwik Trip 1089, subject to the following items. Prior City Council approval of the Construction Drawings for Public Improvements.

1. Prior City Council approval of the Development Agreement regarding the traffic signal.
2. Prior City Council approval of the Construction Drawings for Kwik Trip#1089, including paving improvements, public storm sewers, and traffic signal.
3. Prior City Attorney approval of all easements, bonds, and platting documents for execution by City Council in conjunction with Final Plat approval.
4. Provision of a recorded copy of all legal documents and easements prior to issuance of a Building Permit for the Kwik Star site plan.
5. Approval by Iowa DOT of a permit for the traffic control device and related improvements on W. Bridge Road prior to issuance of a Building Permit for any structure on Lot 1 of Kwik Trip 1089.
6. City Council acceptance of the Public Improvements prior to issuance of a permanent or temporary Certificate of Occupancy for any structure on Lot 1 of Kwik Trip 1089.
7. Payment in full of all fees and professional billings.

KWIK TRIP 1089 FINAL PLAT

INDEX LEGEND

COUNTY: POLK
LOCATION: PART OF LOT 1 IN POLK CITY VENTURE, POLK CITY SE¼, SEC.02-T80N-R25W


SURVEY FOR OWNER: POLK CITY VENTURE LLC
707 SKOKIE BLVD. STE 190
NORTHBROOK, IL 60062-2857

REQUESTOR: KWIK TRIP INC.
CONTACT: KRISTINE RIDDLE
P.O. BOX 2107
LA CROSSE, WI 54602-2107
(608) 781-8988

SURVEYOR AND SURVEY COMPANY:
MATT THOMAS, PLS
THOMAS LAND SURVEYING, LLC
6230 90th AVENUE, INDIANOLA, IA 50125

RETURN TO AND PREPARED BY:
MATT THOMAS, 6230 90th AVENUE,
INDIANOLA, IOWA 50125
(515) 494-6663

DATE OF SURVEY: 08-01-2019 THRU 08-23-2019

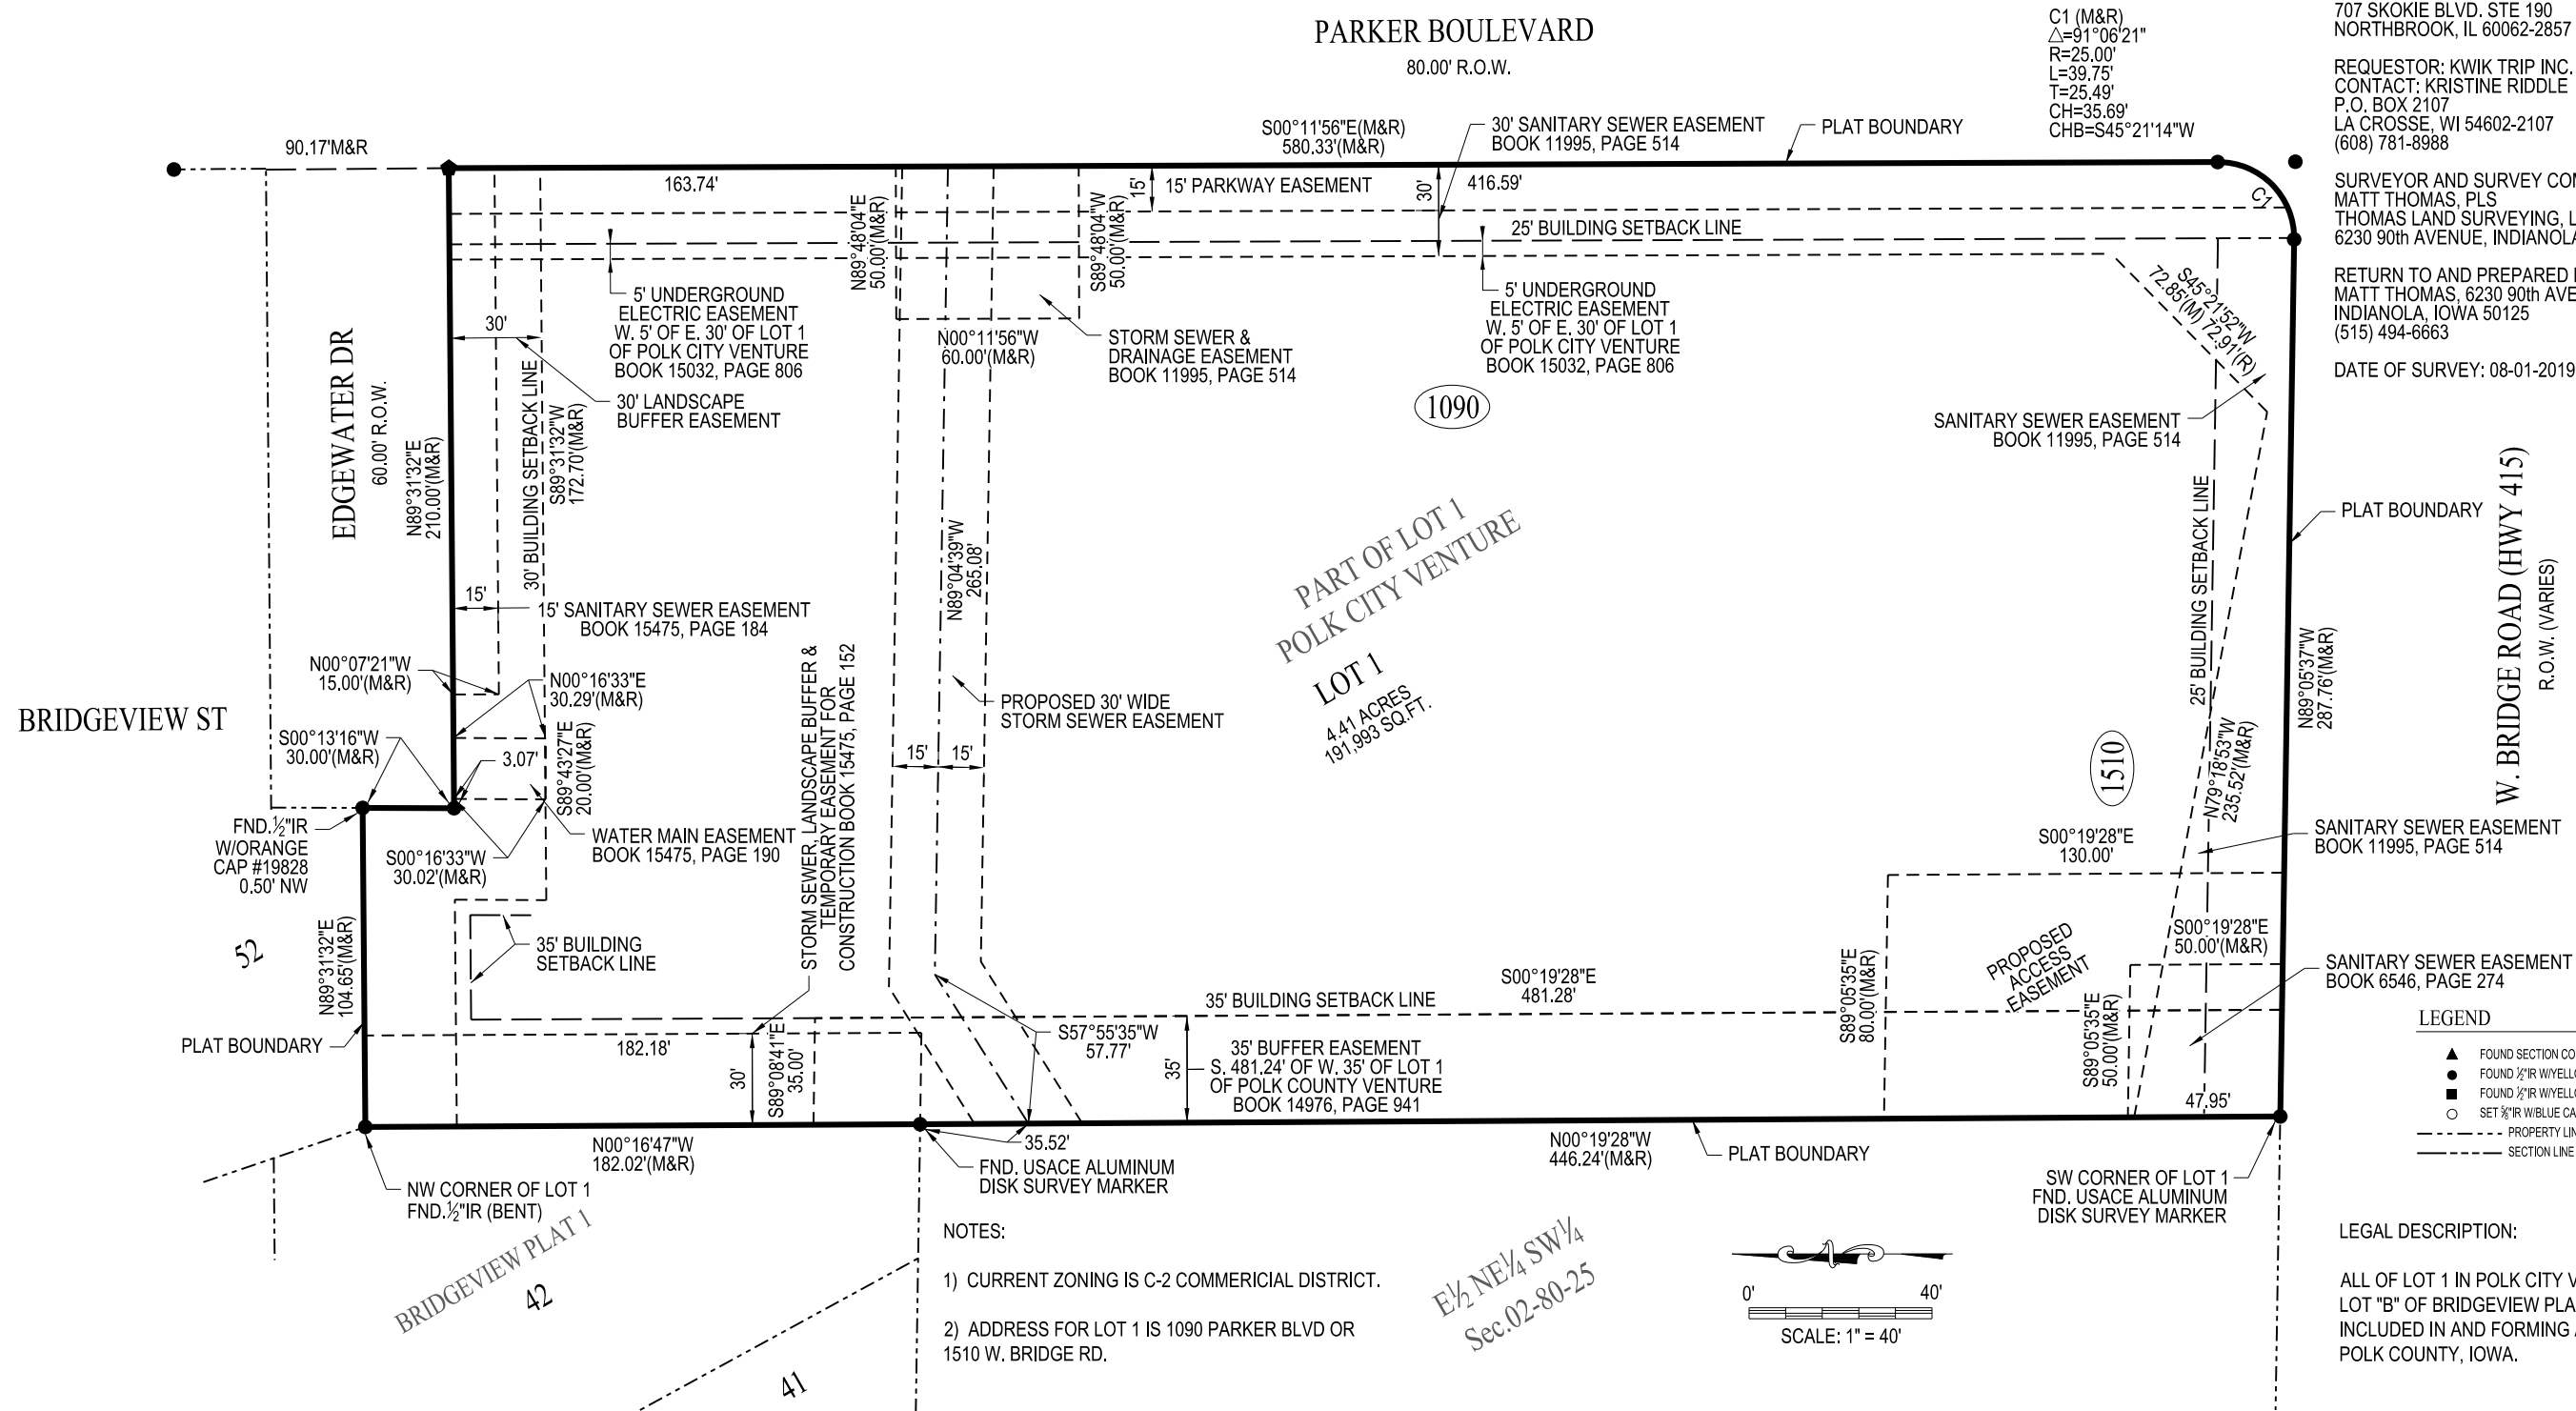

LEGEND	
▲	FOUND SECTION CORNER
●	FOUND ½"IR WYELLOW CAP #4640
■	FOUND ½"IR WYELLOW CAP #19710
○	SET ¾"IR WBLUE CAP #19968
---	PROPERTY LINE
----	SECTION LINE

- NOTES:
- 1) CURRENT ZONING IS C-2 COMMERCIAL DISTRICT.
 - 2) ADDRESS FOR LOT 1 IS 1090 PARKER BLVD OR 1510 W. BRIDGE RD.

LEGAL DESCRIPTION:
ALL OF LOT 1 IN POLK CITY VENTURE, AN OFFICIAL PLAT, EXCEPT LOT "B" OF BRIDGEVIEW PLAT 1, AN OFFICIAL PLAT, ALL NOW INCLUDED IN AND FORMING A PART OF THE CITY OF POLK CITY, POLK COUNTY, IOWA.

TLS
THOMAS
LAND
SURVEYING, LLC
6230 90th AVENUE
INDIANOLA, IA 50125
TELE.: 515.494.6663



I hereby certify that this land surveying document was prepared and the related survey work was performed by me or under my direct personal supervision and that I am a duly licensed Professional Land Surveyor under the laws of the State of Iowa.

Signature: *Matthew J. Thomas* Date: 06-08-2020
Name: (Printed or typed) Matthew J. Thomas
License Number: 19968
My license renewal date is December 31, 2021.
Pages or sheets covered by this seal: THIS SHEET

KWIK TRIP 1089 FINAL PLAT				
REQUESTED BY TITLE HOLDER: POLK CITY VENTURE LLC				
PROJECT NUMBER	19085	COUNTY	DATE DRAWN	YEAR
		POLK	06-08-2020	2020
				SHEET NO.
				1



SITE PLAN REVIEW

Date: June 11, 2020
Project: Kwik Star

Compiled by: Kathleen Connor, Planner
Project No.: 119.0816.01

GENERAL INFORMATION:

Applicant:	Kwik Trip, Inc.
Property Owner:	Polk City Venture LLC
Requested Action:	Approval of Site Plan
Location	Lot 1; Kwik Trip 1089 Plat 1
Size:	4.41 acres
Zoning:	C-2
Propose Use:	Convenience Store with car wash



PROJECT DESCRIPTION:

Kwik Trip proposes construction of a new Kwik Star convenience store on Lot 1 of Kwik Trip 1089 plat. The building will be approximately 7,298 SF in size. The building will be faced primarily with brick. A detached car wash with one bay, approximately 1,620 sf in size, will be constructed on the north side of the property. A canopy is proposed to cover 16 gasoline-pumping stalls and two diesel-pumping stalls.

Access to the site will be from both E. Bridge Road and Parker Boulevard. Public improvements including traffic signal, turning lanes, medians, and storm sewers were shown on the Preliminary Plat for Kwik Trip 1089 and are detailed on the Construction Drawings.

Building signs for the C-store, car wash and canopy signs together total less than the 177 square feet allowed, with no canopy sign larger than 13.87 square feet. The red fascia on the C-store and the red vinyl stripe on the canopy will not be lit.

Water service, including an additional hydrant, will be extended to the building. The building will not be sprinklered. Sanitary sewer construction will include a grease separator. The impact of this development on the existing pumps at the city's lift station is being evaluated. Detention will be provided in a basin in front of the facility.

Street trees will be planted at approximately 40' on center along W. Bridge Road and Parker Blvd. A 30' wide buffer with 6' tall white vinyl screening fence will be installed along the north property line.

A 10' wide recreational trail will be paved along W Bridge Road and the 4' wide sidewalk along Parker Blvd. will be completed. A picnic table area will be provided along Parker Blvd. A bike rack will be added on the south side of the parking lot in reasonable proximity to the recreational trail.

STAFF REVIEW COMMENTS:

Submittal #5 addressed all staff review comments.

RECOMMENDATION:

Staff recommends P&Z approval of the Site Plan for Kwik Star, subject to the following:


1. P&Z comments, if any, shall be addressed prior to the Site Plan being placed on the Council agenda.
2. City Council approval of the Preliminary Plat, Construction Drawings for Public Improvements, and Final Plat for Kwik Trip 1089 prior to approval of this Site Plan.
3. City Council acceptance of the Public Improvements prior to issuance of a permanent or temporary Certificate of Occupancy for this Kwik Star.
4. Recordation of the Final Plat and required platting documents prior to issuance of a Building Permit for this Kwik Star.
5. Payment in full of all fees and professional billings.



1 FRONT ELEVATION
 $\frac{1}{4}'' = 1'-0''$



2 LEFT ELEVATION
 $\frac{3}{16}'' = 1'-0''$

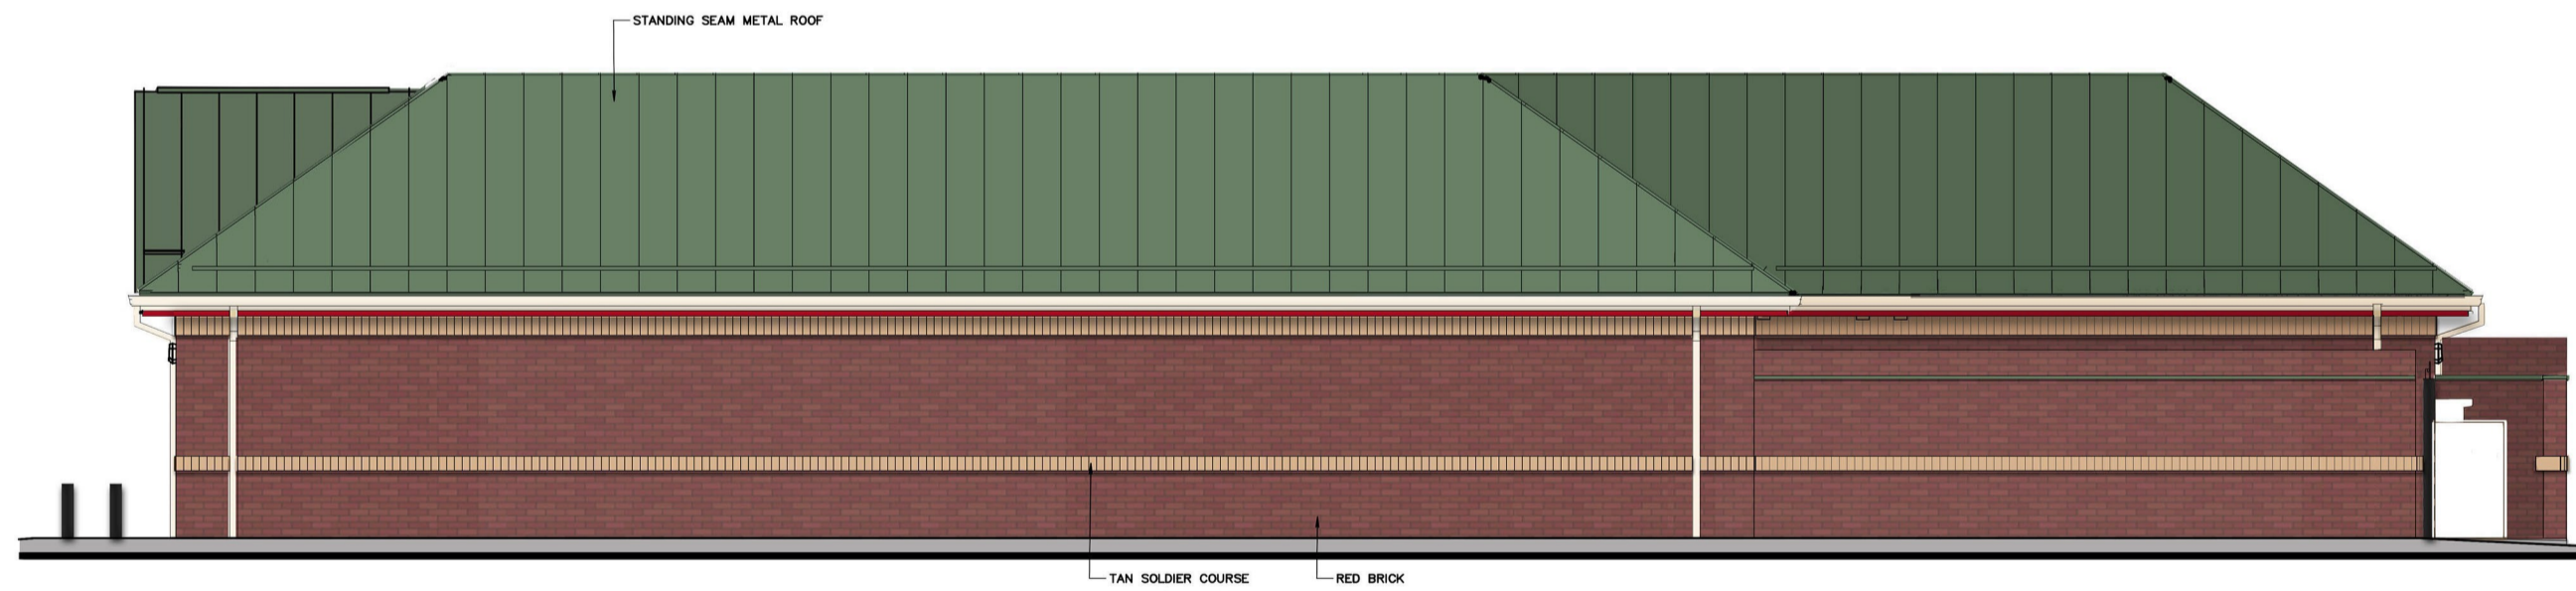

3 REAR ELEVATION
 $\frac{3}{16}'' = 1'-0''$

NOTE; RED FASCIA SHALL NOT BE LIT



4 RIGHT ELEVATION
 $\frac{3}{16}'' = 1'-0''$

VANTAGE
 ARCHITECTS, INC.
 750 N. Third Street
 La Crosse, WI 54601
 Ph (608) 784-2729
 Fax (608) 784-2826



KWIK TRIP, Inc.
 P.O. BOX 2107
 1628 OAK STREET
 LA CROSSE, WI 54602-2107
 PH. (608) 781-8988
 FAX (608) 781-8960



1 FRONT ELEVATION




2 SIDE ELEVATION




KWIK TRIP, Inc.
 P.O. BOX 2107
 1626 OAK STREET
 LA CROSSE, WI 54602-2107
 PH. (608) 781-8988
 FAX (608) 781-8960

12 MPD

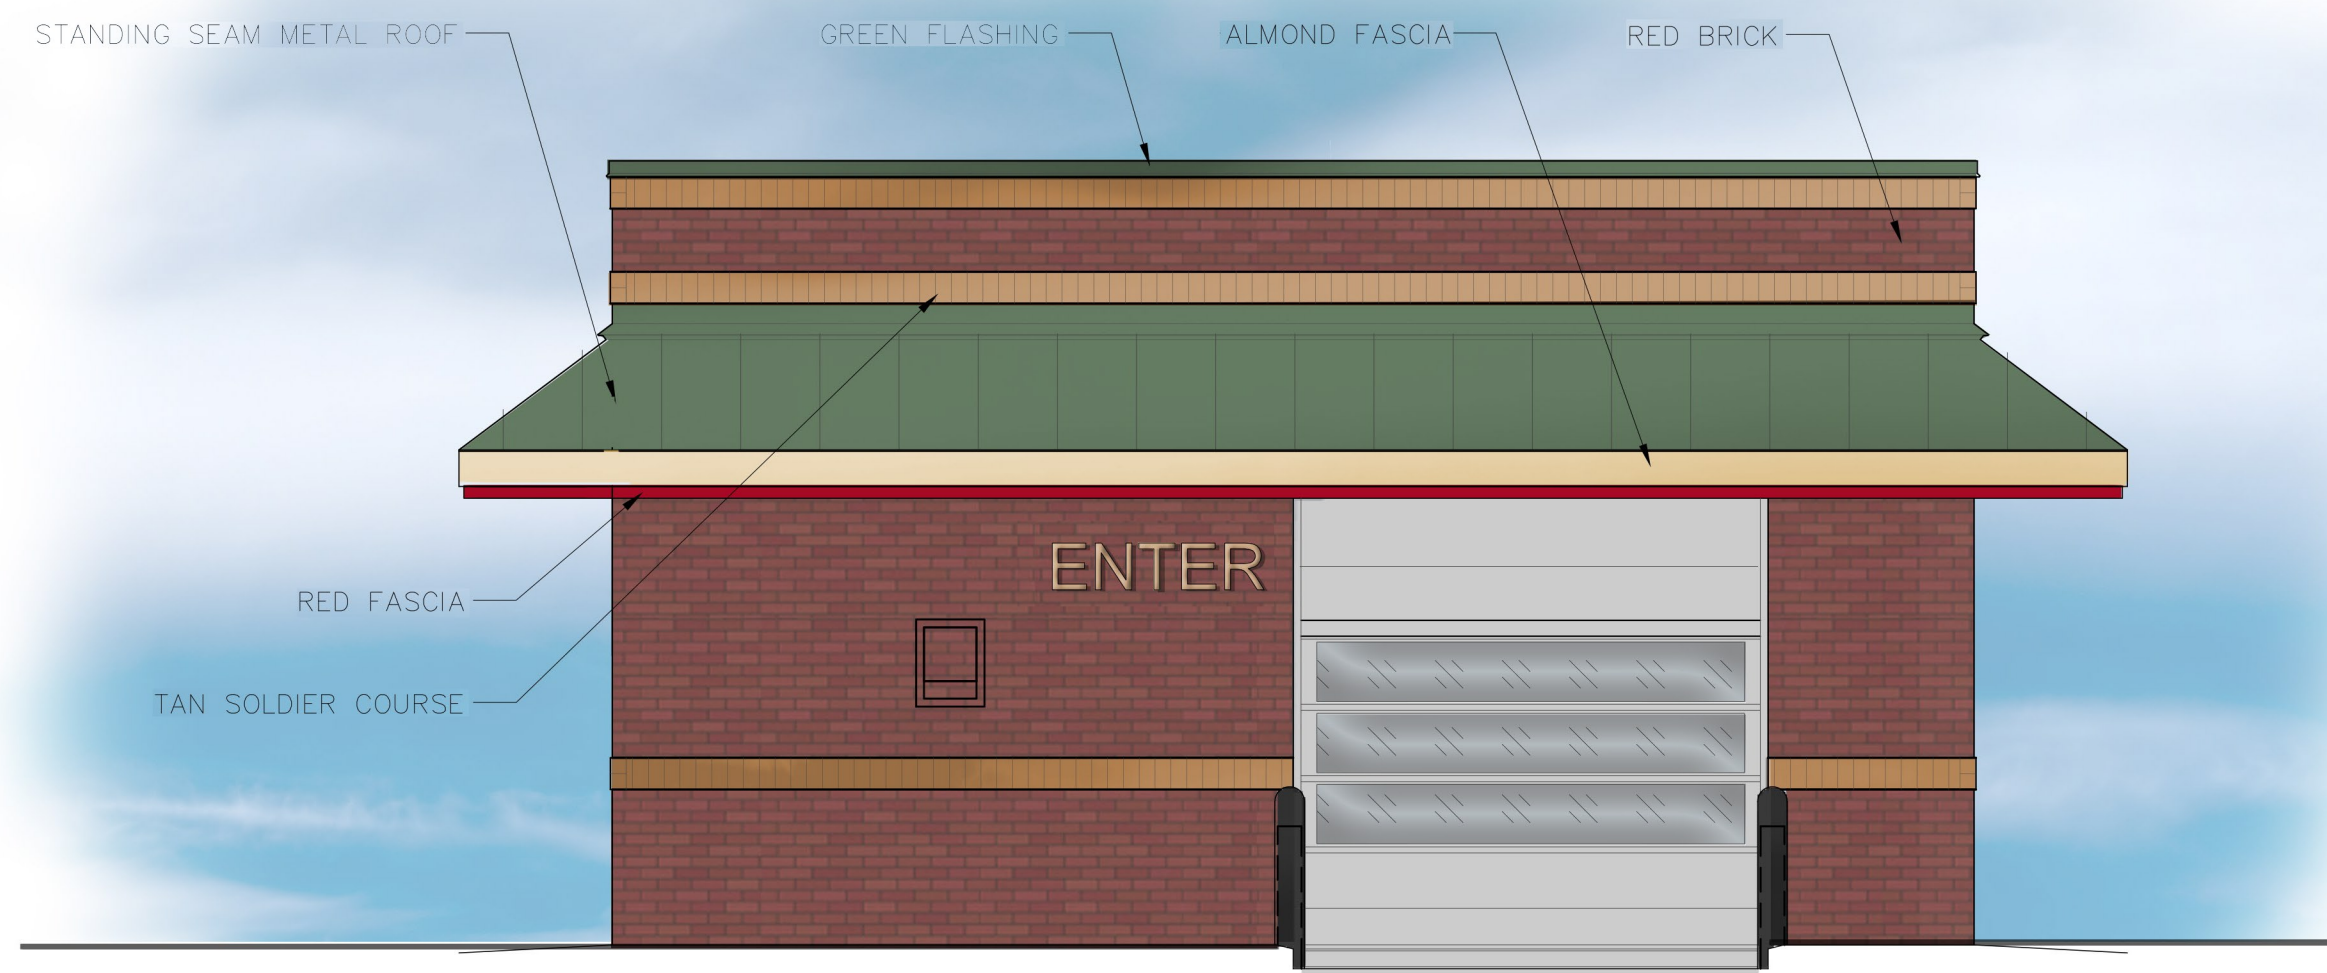

***NOTE: RED FASCIA SHALL BE NOT LIT**
 *All Air Dryers will be installed inside of building

1 EAST ELEVATION
 1/4" = 1'-0"

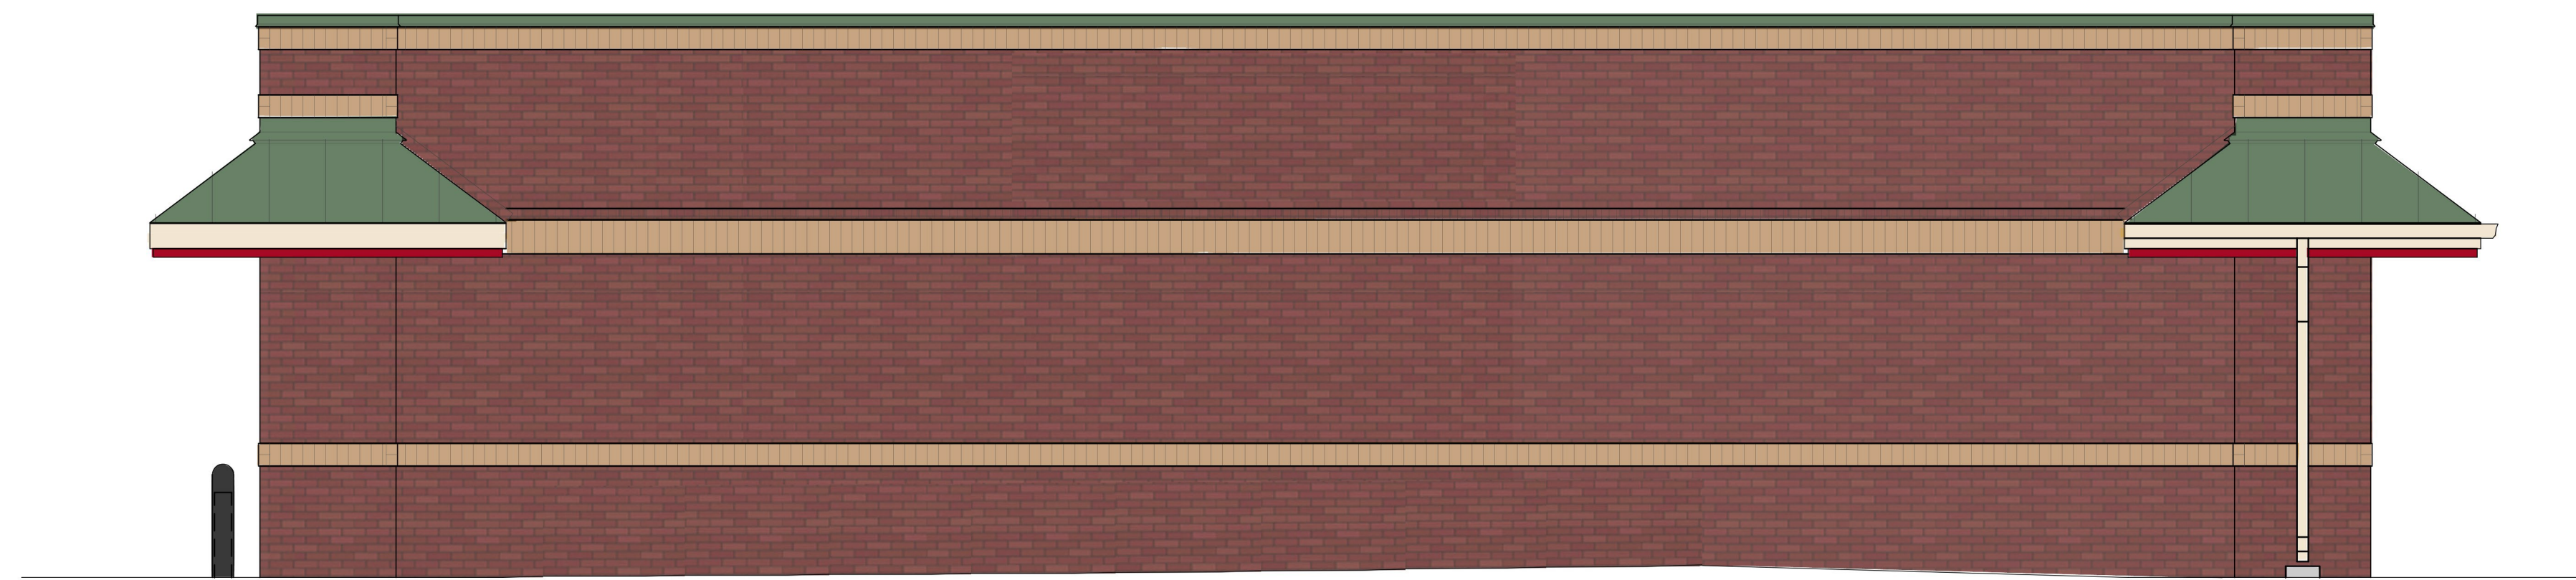

2 NORTH ELEVATION
 1/4" = 1'-0"




3 WEST ELEVATION
 1/4" = 1'-0"




4 SOUTH ELEVATION
 1/4" = 1'-0"

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***NOTE:**
 TEMPORARY OR PERMANENT POSTER-STYLE SIGNS ADVERTISING PRODUCT OR SALES SHALL NOT BE MOUNTED TO THE EXTERIOR WALLS OF C-STORE OR CARWASH BUILDINGS, FENCES, TRASH ENCLOSURE, GASOLINE CANOPY SUPPORTS OR SIMILAR EXTERIOR LOCATIONS

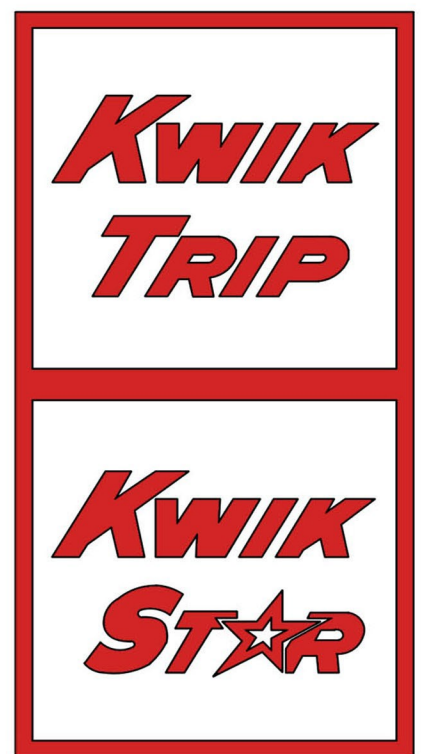TEMPORARY OR PERMANENT SIGNS DISPLAYED UNDER THE PUMP CANOPIES OR ON PUMP DISPENSERS SHALL HAVE LETTERS NO TALLER THAN 4 INCHES AND EACH SIGN SHALL HAVE A TOTAL SIGN AREA NO GREATER THAN 2 SQUARE FEET

- PROPOSED SIGNS:**
- #01 18 LED KWIK STAR BUILDING LETTERS
 - #02 CARWASH DIRECTIONAL BUILDING SIGN
 - #03 18" LED KWIK STAR BUILDING LETTERS
 - #04 18" LED KWIK STAR CANOPY LETTERS
 - #05 18" LED KWIK STAR CANOPY LETTERS
 - #06 18" LED DIESEL CANOPY SIGN
 - #07 18" LED DIESEL CANOPY SIGN
 - #08 18" LED CARWASH BUILDING LETTERS
 - #09 CARWASH ENTER

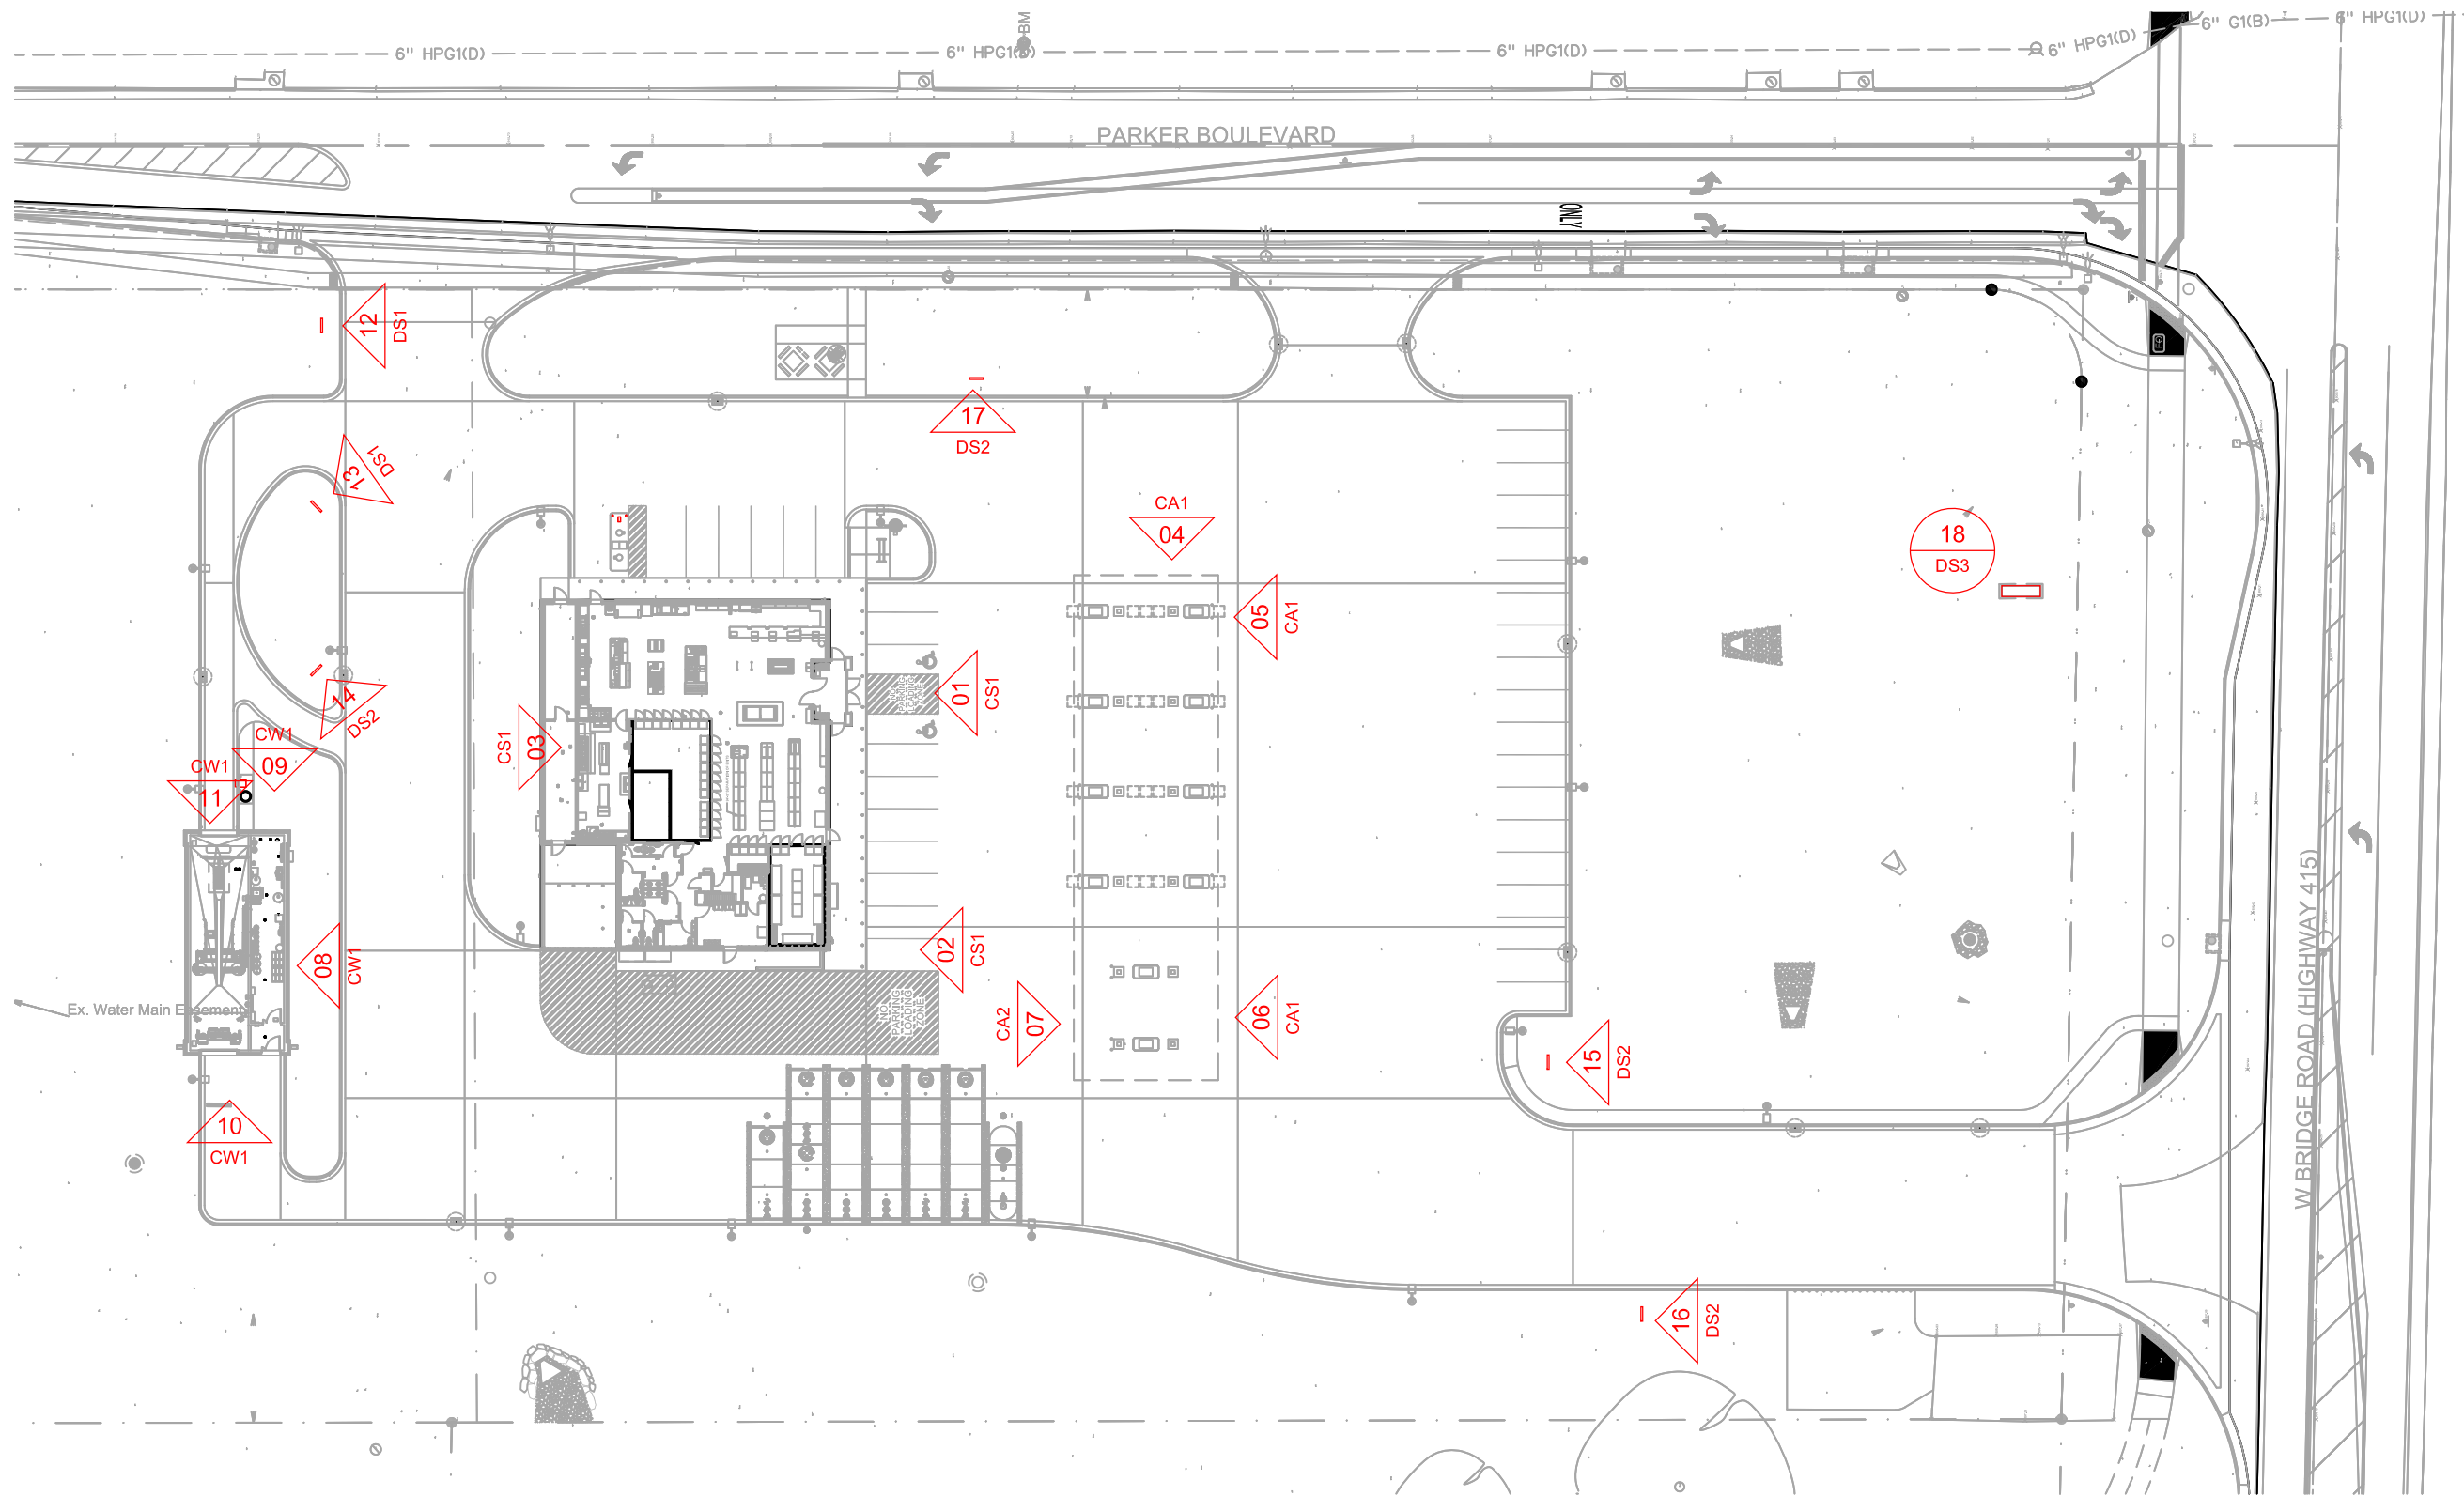- #10 CARWASH EXIT
- #11 CARWASH INFORMATIONAL SIGN
- #12 DRIVEWAY DIRECTIONAL
- #13 DRIVEWAY DIRECTIONAL
- #14 DRIVEWAY DIRECTIONAL
- #15 DRIVEWAY DIRECTIONAL
- #16 DRIVEWAY DIRECTIONAL
- #17 DRIVEWAY DIRECTIONAL
- #18 FREESTANDING MONUMENT SIGN

SITE PLAN
 1" = 50'-0"




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SITE PLAN
 CONVENIENCE STORE #1089
 W. SIDE DIESEL & ATTACHED CW
 NW 112TH AVE
 POLK CITY, IA


#	DATE	DESCRIPTION
2020/02/24	2020/02/24	SITE REVISION
2020/04/29	2020/04/29	SIGN UPDATE
2020/05/21	2020/05/21	CITY COMMENTS

DRAWN BY: KMK
 SCALE: MULTIPLE
 PROJ. NO.: 0001
 DATE: 2019-08-06
 SHEET: SP1

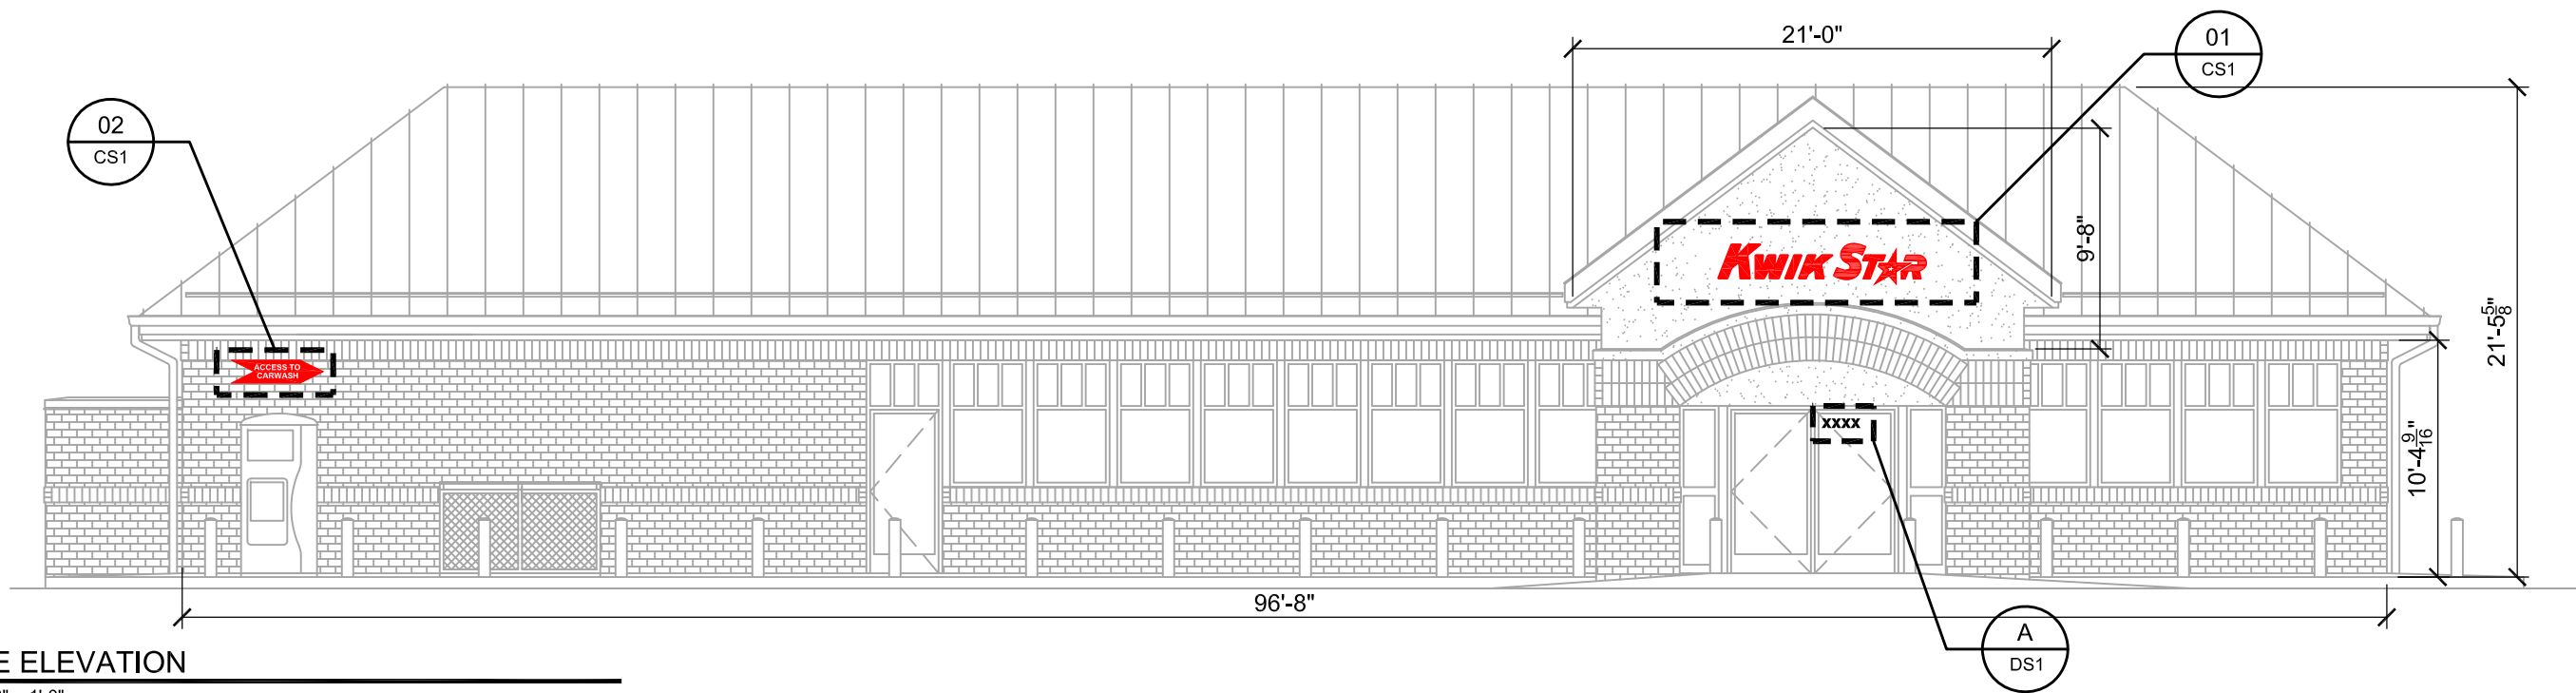

STORE ELEVATION


SCALE: 1/8" = 1'-0"

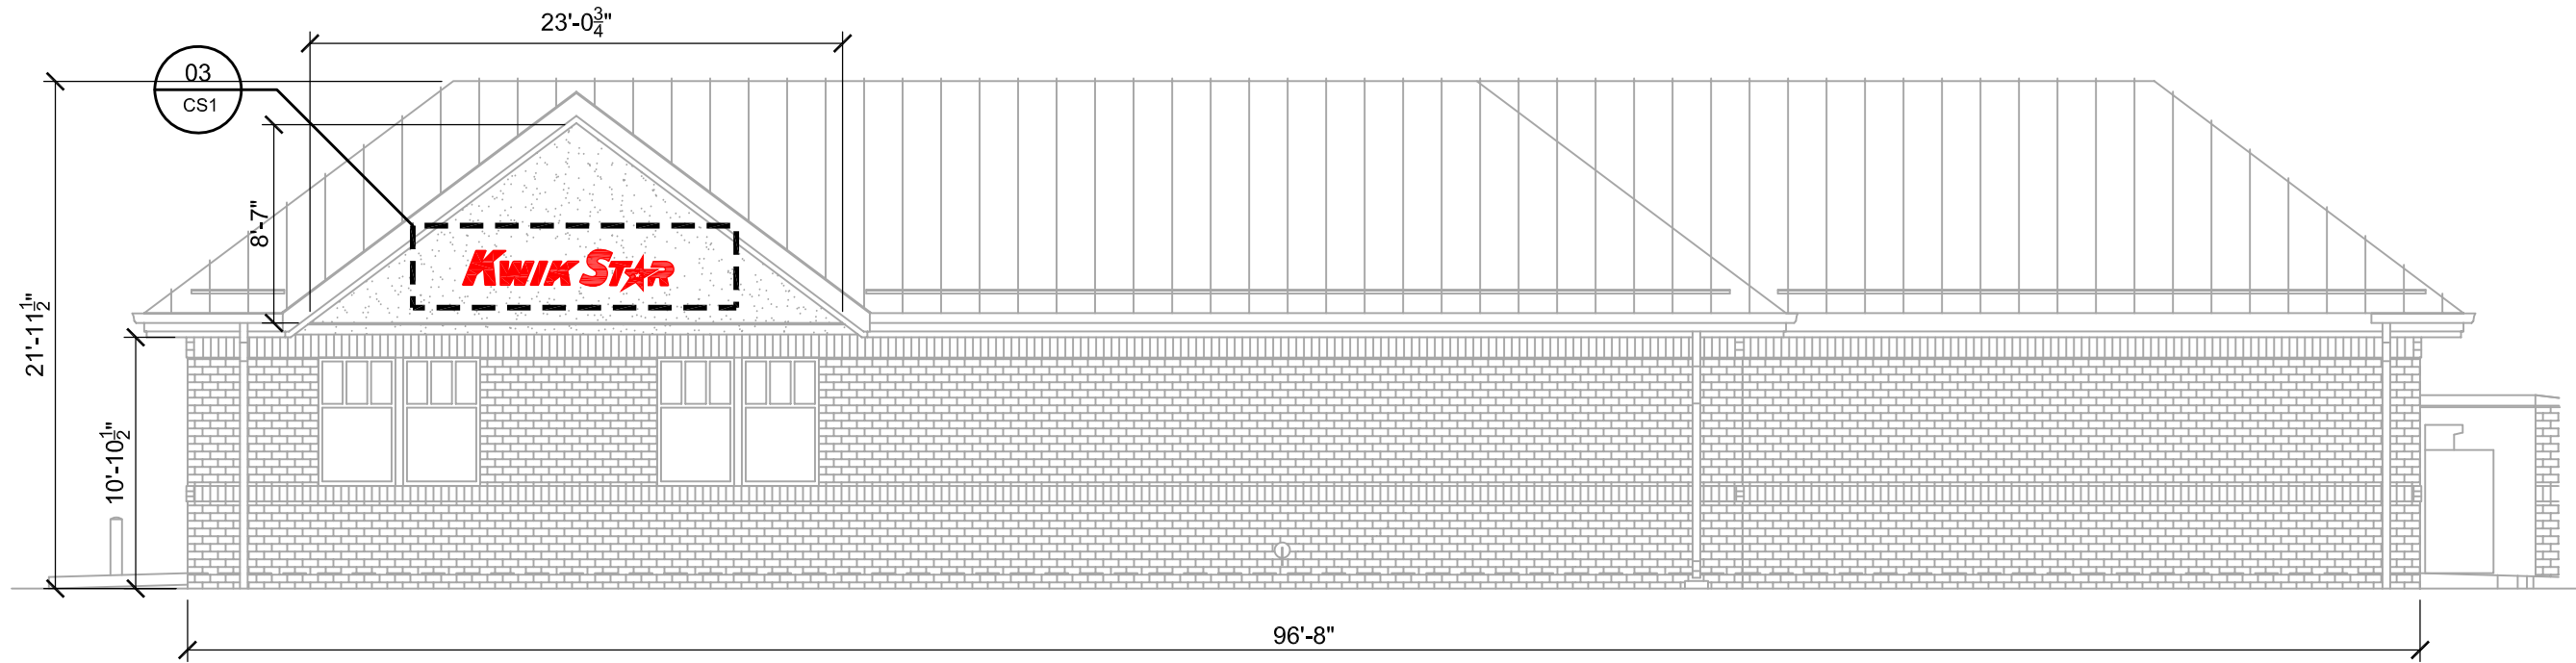

STORE ELEVATION

SCALE: 1/8" = 1'-0"

*NOTE: RED FASCIA SHALL NOT BE LIT

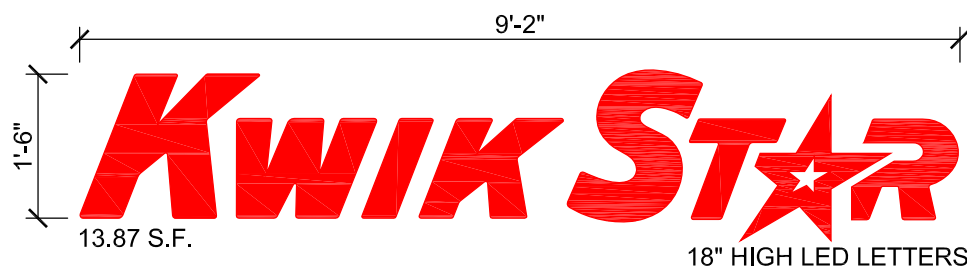

LOGO DETAIL - SIGNS #01 & #03

SCALE: 1/2" = 1'-0"



NON-LIT DIRECTIONAL SIGN
 WHITE VINYL ON RED ALUMINUM
 1'-0"H X 4'-0"W = 4.0 SQ FT

DIRECTIONAL SIGN #02

SCALE: 1/2" = 1'-0"

**Kwik
TRIP**

**Kwik
STAR**

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 P.O. BOX 2107
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 LA CROSSE, WI 54602-2107
 PH. (608) 781-8988
 FAX (608) 781-8960


CONVENIENCE STORE SIGNAGE

CONVENIENCE STORE #1089
 W. SIDE DIESEL & ATTACHED CW

NW 112TH AVE
 POLK CITY, IA

#	DATE	DESCRIPTION
△	2020/02/24	SITE REVISION
△	2020/04/29	SIGN UPDATE
△	2020/05/21	CITY COMMENTS


DRAWN BY	KMK
SCALE	MULTIPLE
PROJ. NO.	0001
DATE	2019-08-06
SHEET	CS1

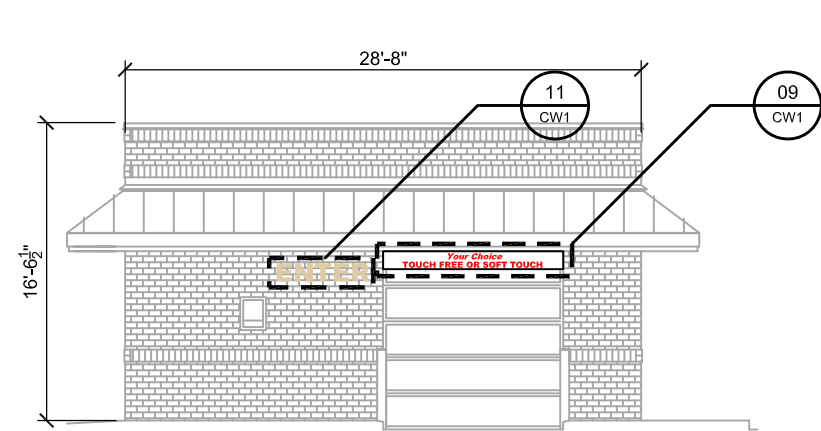

ENTER: 12" TALL X 48" LONG
DESERT SAND (TAN) LETTERS


EAST ELEVATION

SCALE: 3/32" = 1'-0"

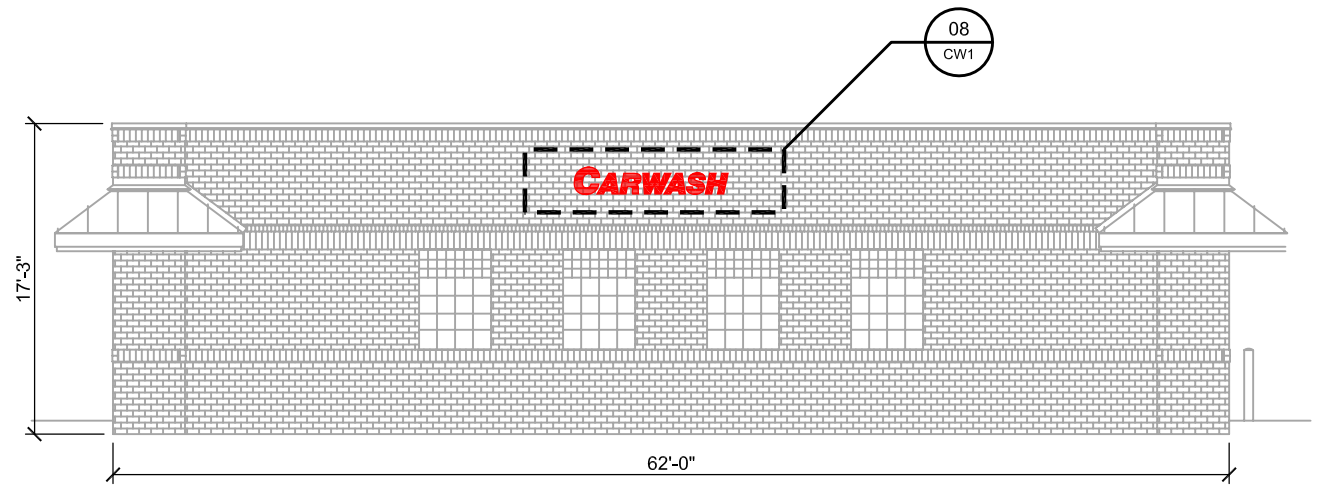

SOUTH ELEVATION

SCALE: 3/32" = 1'-0"

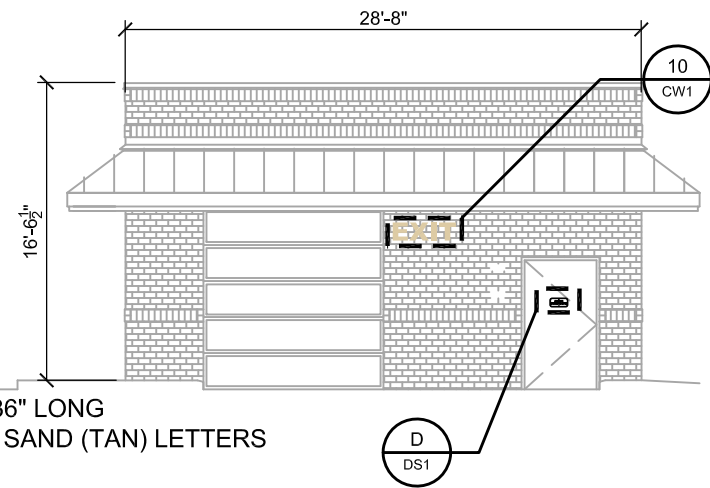


EXIT: 12" TALL X 36" LONG
DESERT SAND (TAN) LETTERS

WEST ELEVATION


SCALE: 3/32" = 1'-0"

*NOTE: RED FASCIA SHALL NOT BE LIT

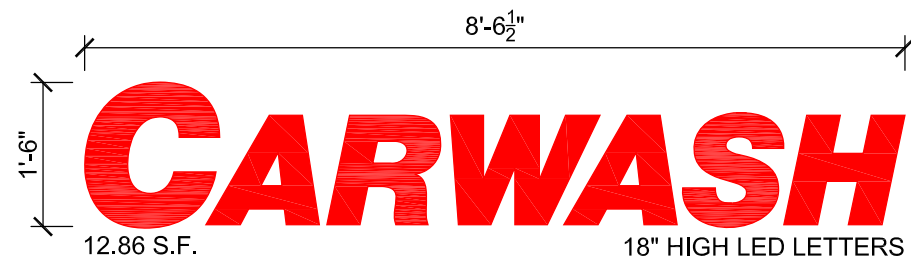

LOGO DETAIL - SIGN #08

SCALE: 1/2" = 1'-0"

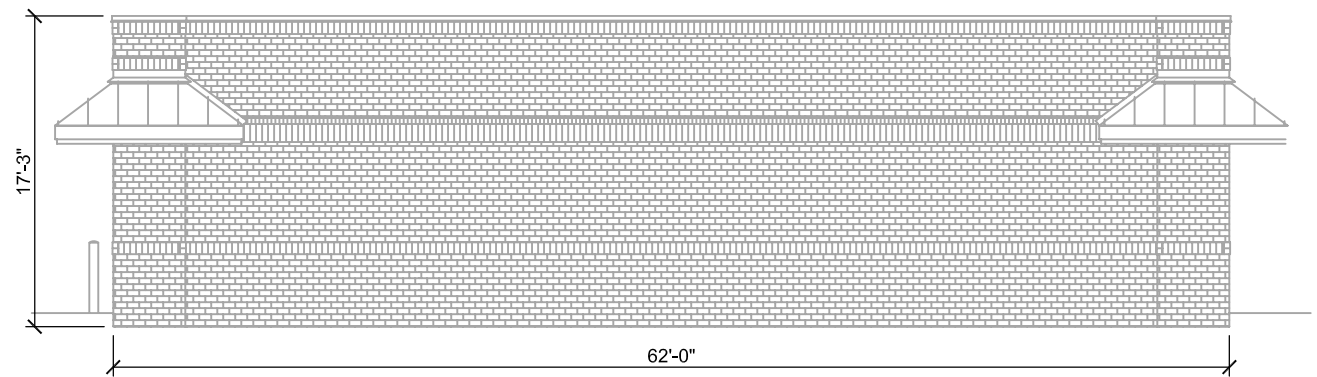

NORTH ELEVATION

SCALE: 3/32" = 1'-0"



NON-LIT INFORMATIONAL SIGN
RED VINYL ON WHITE ALUMINUM
1'-0"H X 10'-0"W = 10.0 SQ FT

INFORMATIONAL SIGN #09

SCALE: 1/2" = 1'-0"

**Kwik
TRIP**

**Kwik
STAR**


KWIK TRIP, Inc.
P.O. BOX 2107
1626 OAK STREET
LA CROSSE, WI 54602-2107
PH. (608) 781-8988
FAX (608) 781-8960

CARWASH SIGNAGE

CONVENIENCE STORE #1089
W. SIDE DIESEL & ATTACHED CW


NW 112TH AVE
POLK CITY, IA

#	DATE	DESCRIPTION
2020/02/24	2020/02/24	SITE REVISION
2020/04/29	2020/04/29	SIGN UPDATE
2020/05/21	2020/05/21	CITY COMMENTS
DRAWN BY		KMK
SCALE		MULTIPLE
PROJ. NO.		0001
DATE		2019-08-06
SHEET		CW1

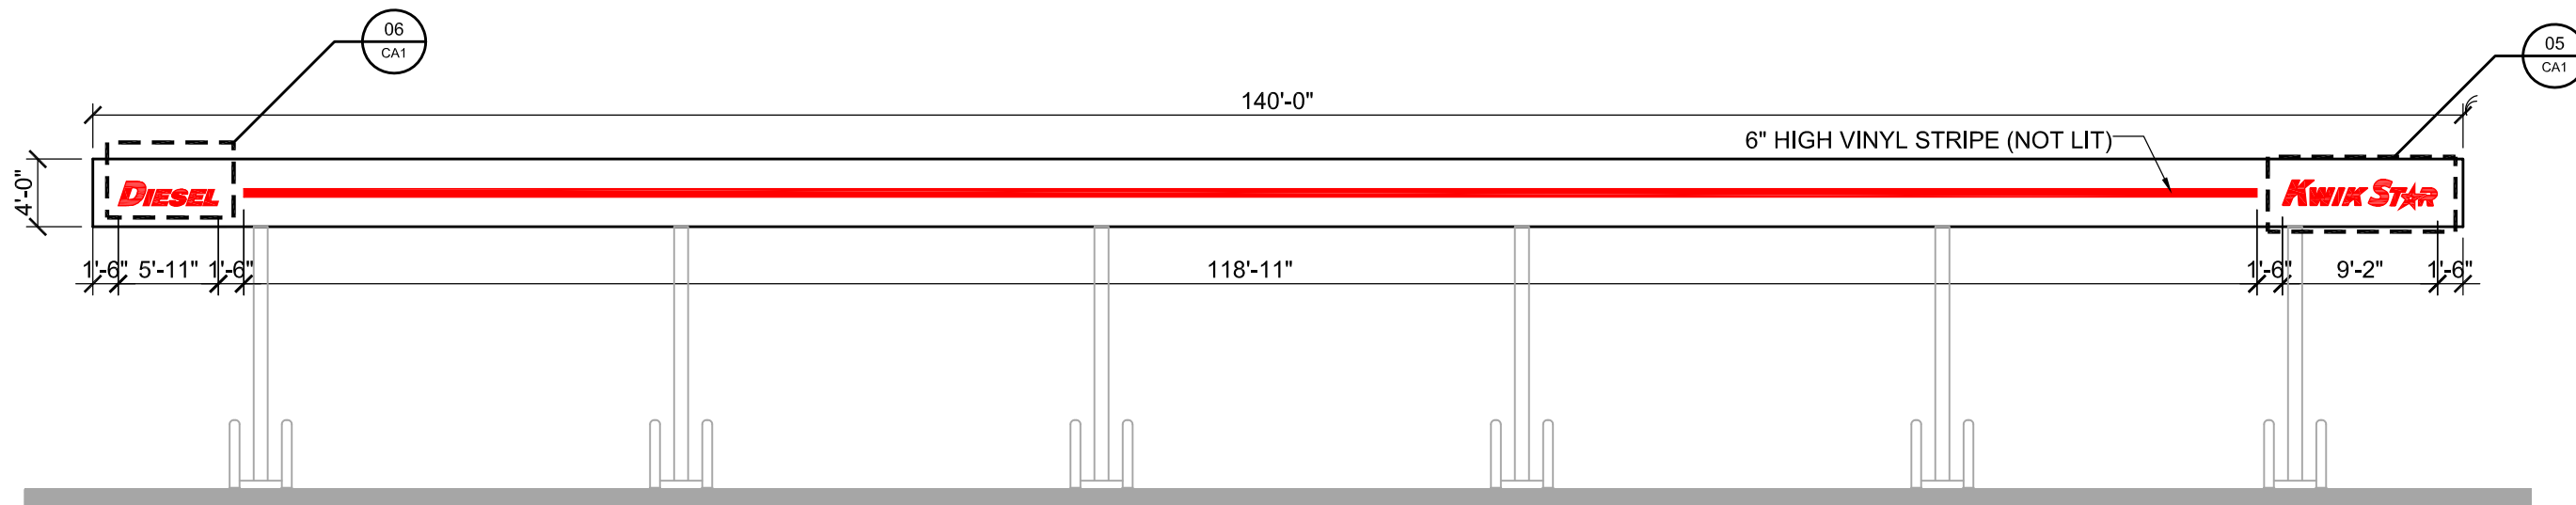


CANOPY ELEVATION

SCALE: 3/32" = 1'-0"

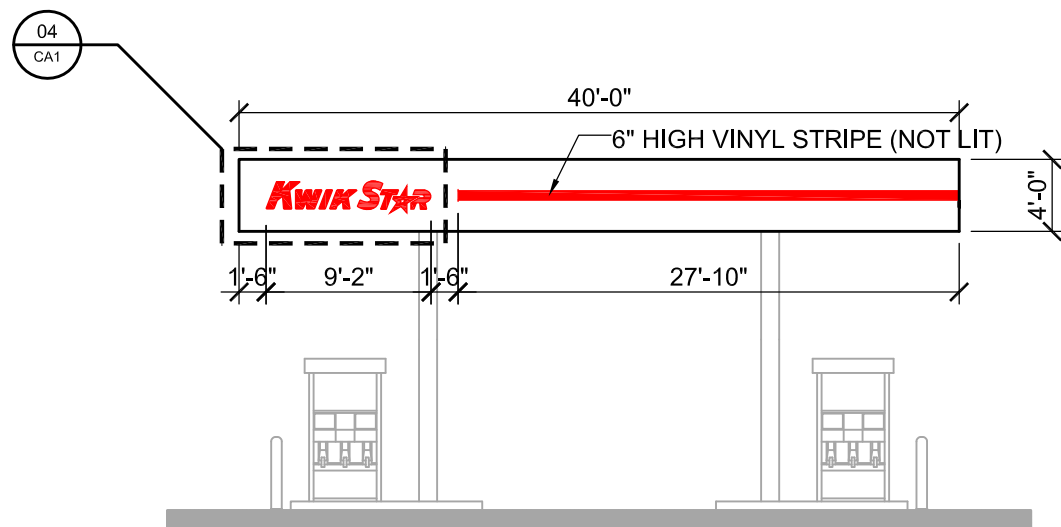


CANOPY ELEVATION

SCALE: 3/32" = 1'-0"

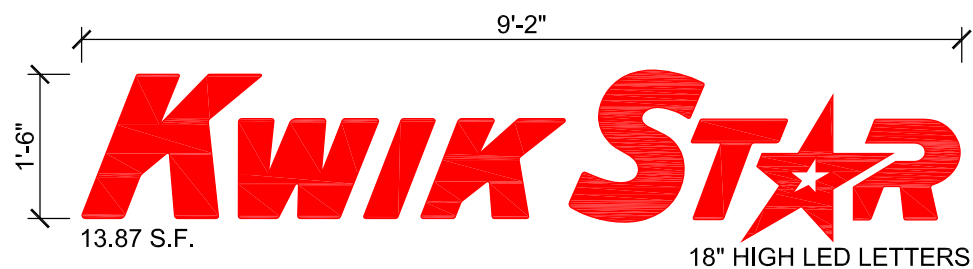

LOGO DETAIL - SIGNS #04 & #05

SCALE: 1/2" = 1'-0"

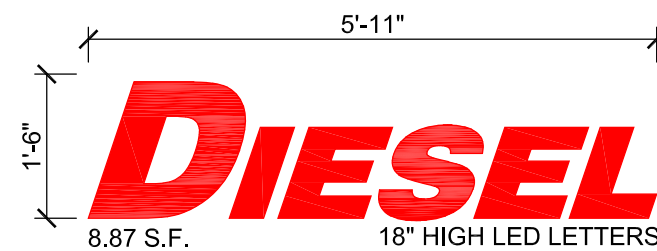

LOGO DETAIL - SIGN #06


SCALE: 1/2" = 1'-0"



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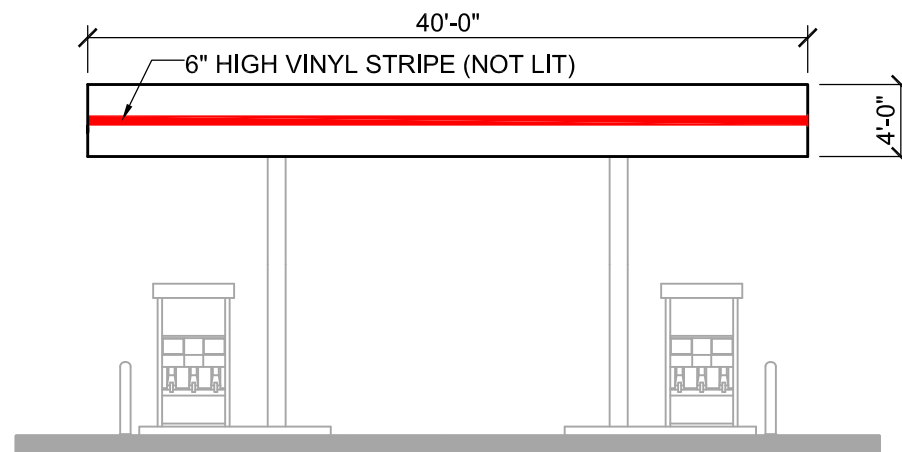
CANOPY SIGNAGE
 CONVENIENCE STORE #1089
 W. SIDE DIESEL & ATTACHED CW
 NW 112TH AVE
 POLK CITY, IA

#	DATE	DESCRIPTION
△	2020/02/24	SITE REVISION
△	2020/04/29	SIGN UPDATE
△	2020/05/21	CITY COMMENTS
DRAWN BY		KMK
SCALE		MULTIPLE
PROJ. NO.		0001
DATE		2019-08-06
SHEET		CA1

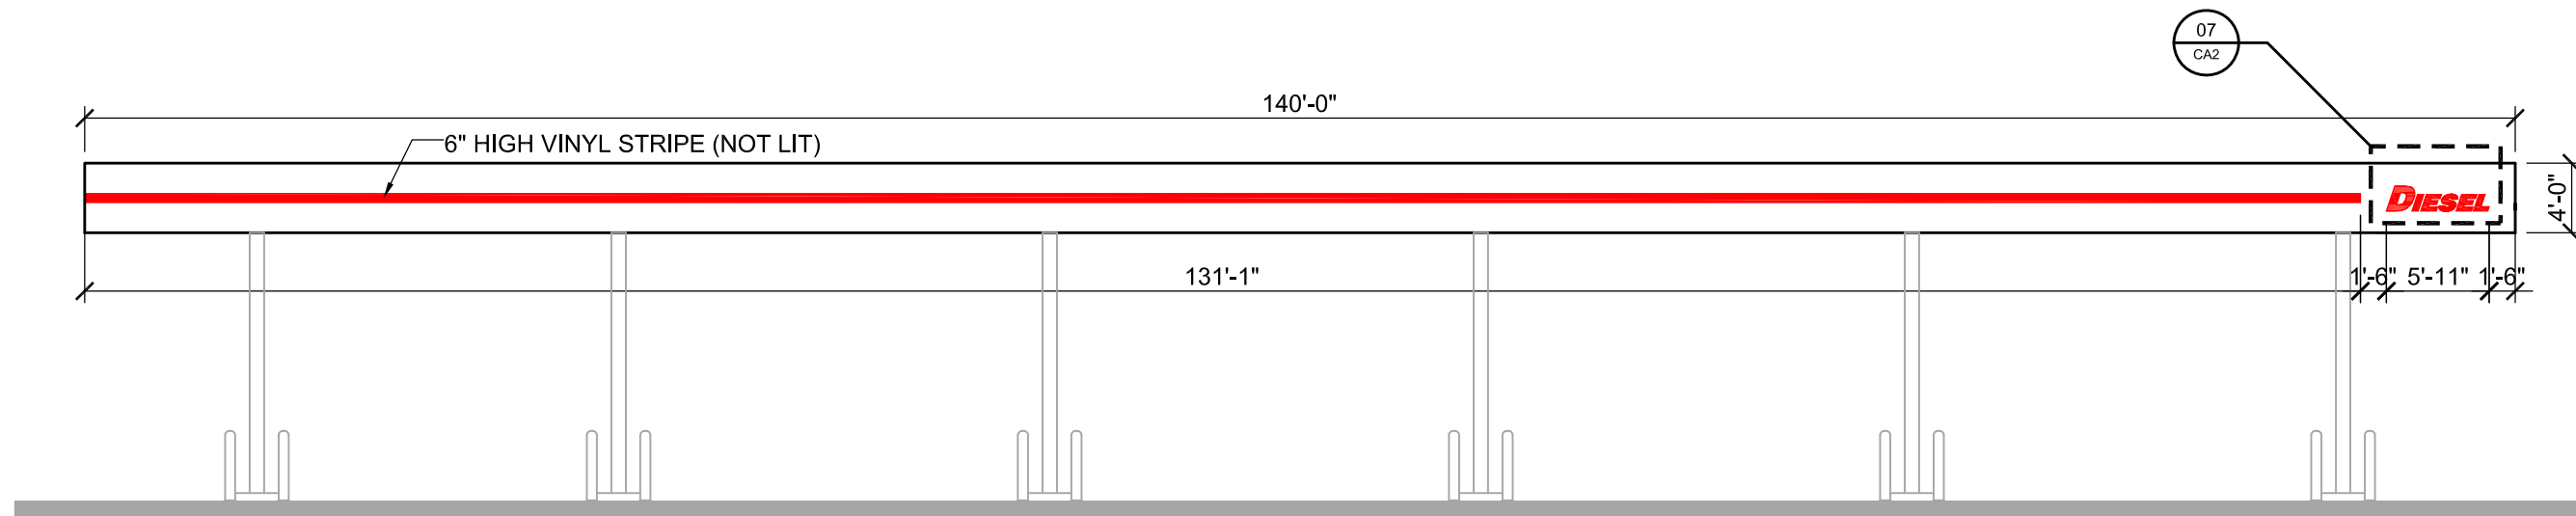

CANOPY ELEVATION

SCALE: 3/32" = 1'-0"



CANOPY ELEVATION

SCALE: 3/32" = 1'-0"



LOGO DETAIL - SIGN #07

SCALE: 1/2" = 1'-0"



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CANOPY SIGNAGE
CONVENIENCE STORE #1089
W. SIDE DIESEL & ATTACHED CW
NW 112TH AVE
POLK CITY, IA

#	DATE	DESCRIPTION
△	2020/02/24	SITE REVISION
△	2020/04/29	SIGN UPDATE
△	2020/05/21	CITY COMMENTS


DRAWN BY	KMK
SCALE	MULTIPLE
PROJ. NO.	0001
DATE	2019-08-06
SHEET	CA2



5" WHITE VINYL ADDRESS LETTERS
ON GLASS DOOR AS SHOWN ABOVE
(VERIFY ACTUAL NUMBERS WITH PROJECT MANAGER)

ADDRESS SIGN A

SCALE: 3/4" = 1'-0"

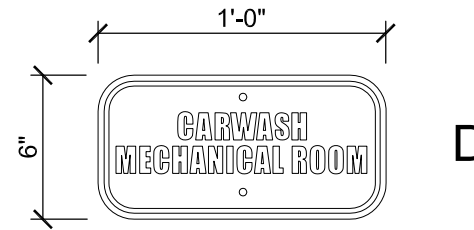

D

INFORMATIONAL SIGN D

SCALE: 3/4" = 1'-0"

GENERAL SPECIFICATIONS	
(A)	ROOM SIGNS Qty: 3 total (different copy on each) Size: per art Material: white sign blank Finish: cut vinyl
Install along with various signs for same site, crew to give to KT trim guys to install.	

**Kwik
TRIP**


**Kwik
STAR**

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1626 OAK STREET
LA CROSSE, WI 54602-2107
PH. (608) 781-8988
FAX (608) 781-8960

DOUBLE SIDED DIRECTIONAL SIGN

NORTH SIDE

SOUTH SIDE

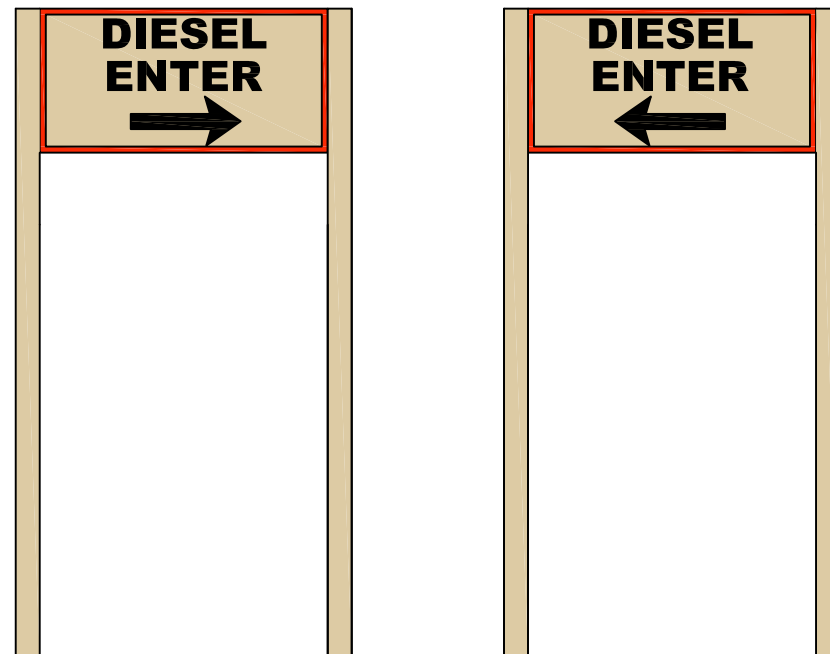


NON-LIT DIRECTIONAL SIGN
RED & BLACK VINYL ON LIGHT BEIGE ALUMINUM
1'-0"H X 2'-0"W X 4'-6"T= 2.00 SQ FT
TEXT IS TO BE NO GREATER THAN 4"

DIRECTIONAL SIGN #12

SCALE: 3/4" = 1'-0"

SINGLE SIDED DIRECTIONAL SIGN

SOUTH SIDE

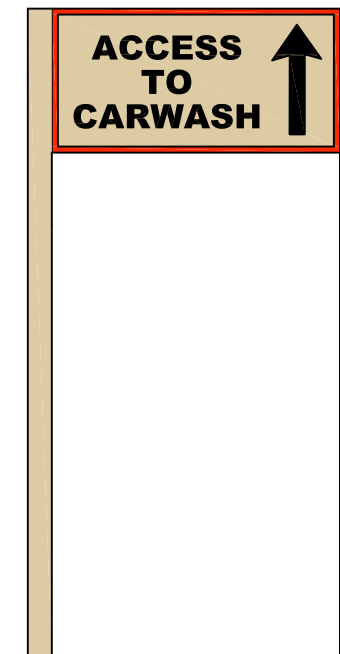


NON-LIT DIRECTIONAL SIGN
RED & BLACK VINYL ON LIGHT BEIGE ALUMINUM
1'-0"H X 2'-0"W X 4'-6"T= 2.00 SQ FT
TEXT IS TO BE NO GREATER THAN 4"

DIRECTIONAL SIGN #13


SCALE: 3/4" = 1'-0"

DIRECTIONAL SIGNAGE	CONVENIENCE STORE #1089	
	W. SIDE DIESEL & ATTACHED CW	
	NW 112TH AVE POLK CITY, IA	
#	DATE	DESCRIPTION
▲	2020/02/24	SITE REVISION
▲	2020/04/29	SIGN UPDATE
▲	2020/05/21	CITY COMMENTS
DRAWN BY: KMK		
SCALE: MULTIPLE		
PROJ. NO.: 0001		
DATE: 2019-08-06		
SHEET		DS1

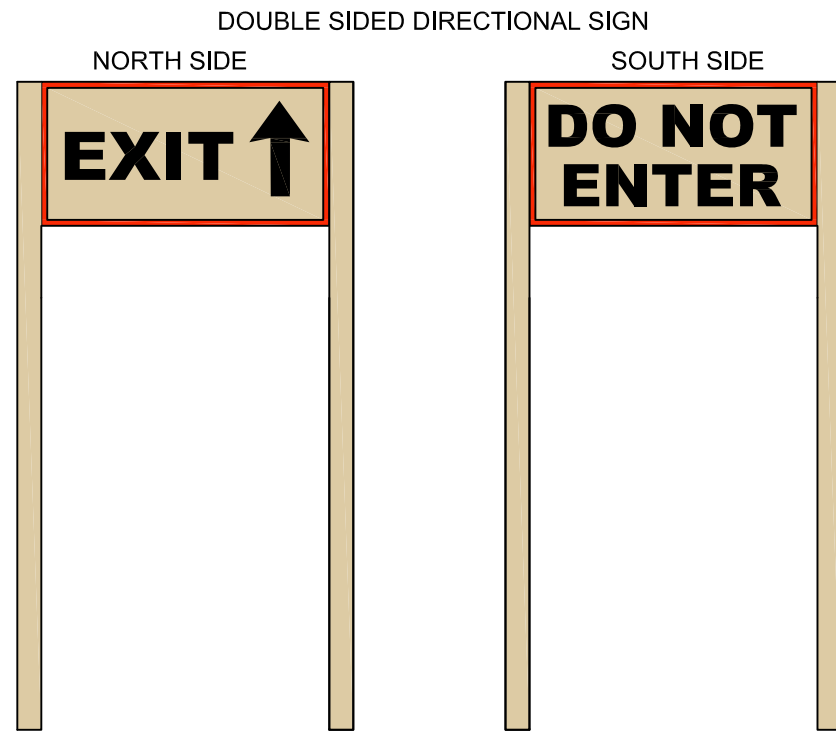

DOUBLE SIDED DIRECTIONAL SIGN
NORTH SIDE SOUTH SIDE

NON-LIT DIRECTIONAL SIGN
RED & BLACK VINYL ON LIGHT BEIGE ALUMINUM
1'-0"H X 2'-0"W X 4'-6"T= 2.00 SQ FT
TEXT IS TO BE NO GREATER THAN 4"

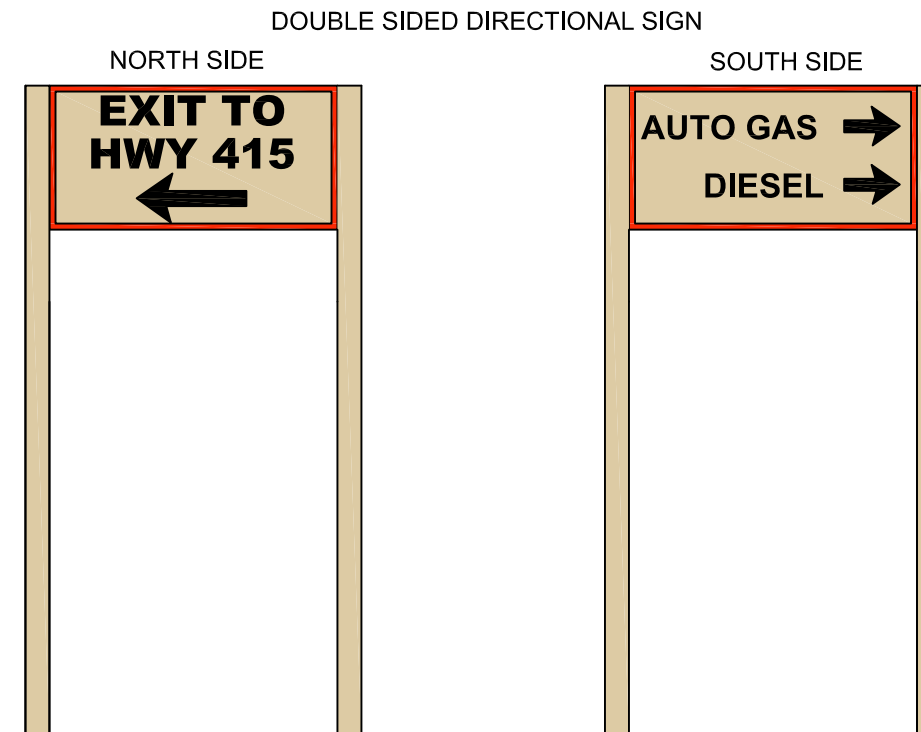

DOUBLE SIDED DIRECTIONAL SIGN
NORTH SIDE SOUTH SIDE


NON-LIT DIRECTIONAL SIGN
RED & BLACK VINYL ON LIGHT BEIGE ALUMINUM
1'-0"H X 2'-0"W X 4'-6"T= 2.00 SQ FT
TEXT IS TO BE NO GREATER THAN 4"

DIRECTIONAL SIGN #14

SCALE: 3/4" = 1'-0"

DIRECTIONAL SIGN #15

SCALE: 3/4" = 1'-0"

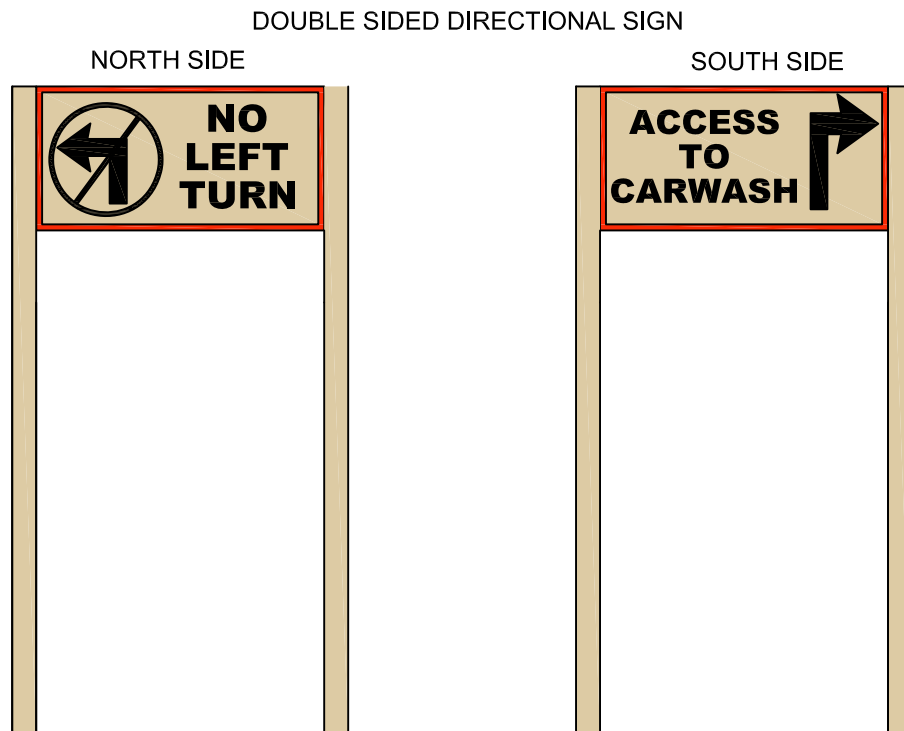


DOUBLE SIDED DIRECTIONAL SIGN
NORTH SIDE SOUTH SIDE

NON-LIT DIRECTIONAL SIGN
RED & BLACK VINYL ON LIGHT BEIGE ALUMINUM
1'-0"H X 2'-0"W X 4'-6"T= 2.00 SQ FT
TEXT IS TO BE NO GREATER THAN 4"

DIRECTIONAL SIGN #16

SCALE: 3/4" = 1'-0"

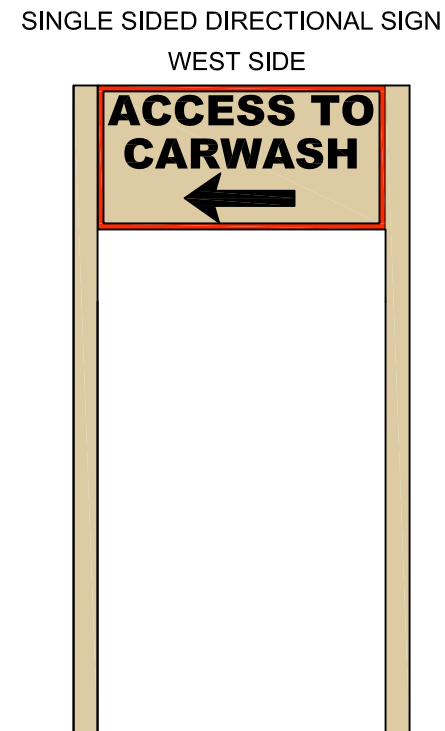

SINGLE SIDED DIRECTIONAL SIGN
WEST SIDE

NON-LIT DIRECTIONAL SIGN
RED & BLACK VINYL ON LIGHT BEIGE ALUMINUM
1'-0"H X 2'-0"W X 4'-6"T= 2.00 SQ FT
TEXT IS TO BE NO GREATER THAN 4"

DIRECTIONAL SIGN #17

SCALE: 3/4" = 1'-0"



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LA CROSSE, WI 54602-2107
PH. (608) 781-8988
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DIRECTIONAL SIGNAGE
CONVENIENCE STORE #1089
W. SIDE DIESEL & ATTACHED CW
NW 112TH AVE
POLK CITY, IA

#	DATE	DESCRIPTION
△	2020/02/24	SITE REVISION
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DRAWN BY: KMK		
SCALE: MULTIPLE		
PROJ. NO.: 0001		
DATE: 2019-08-06		
SHEET		DS2

#18 KWIK STAR FREESTANDING MONUMENT SIGN

SEE ATTACHMENT FROM LA CROSSE SIGN CO

**KWIK
TRIP**

**KWIK
STAR**

KWIK TRIP, Inc.
P.O. BOX 2107
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LA CROSSE, WI 54602-2107
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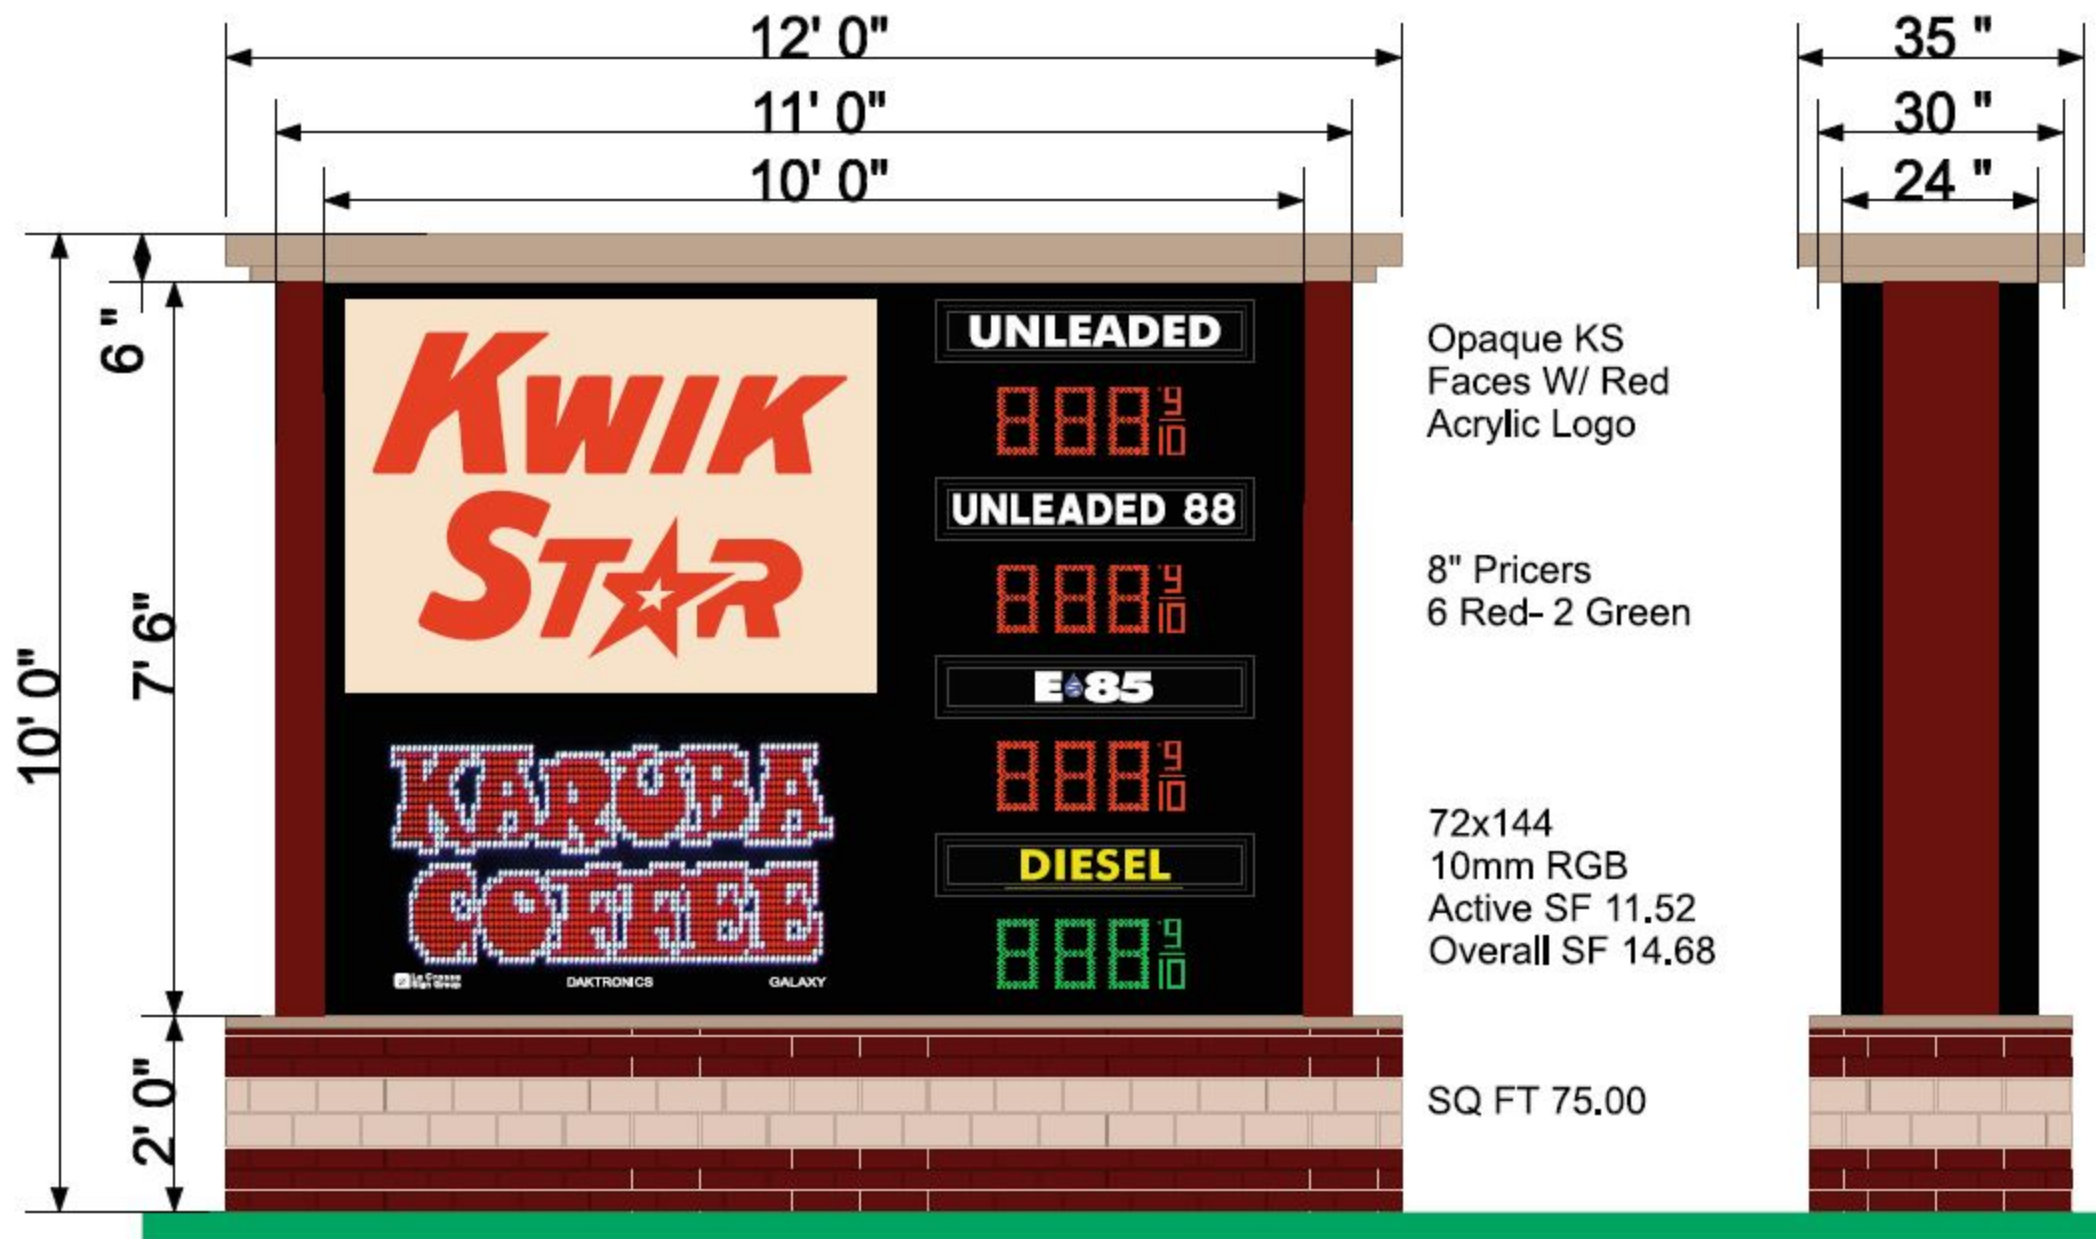
DIRECTIONAL SIGNAGE

CONVENIENCE STORE #1089
W. SIDE DIESEL & ATTACHED CW

NW 112TH AVE
POLK CITY, IA

#	DATE	DESCRIPTION
△	2020/02/24	SITE REVISION

DRAWN BY: KMK
SCALE: MULTIPLE
PROJ. NO.: 0001
DATE: 2019-08-06
SHEET: DS3



Approved by: _____ Date: _____ Landlord: _____ Date: _____


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lacrossesign.com		DESIGN	SALES	FILE	COLOR KEY	*COLORS ON SKETCH ARE ONLY A REPRESENTATION, ACTUAL COLOR OF FINISHED PRODUCT MAY DIFFER	
 <p>La Crosse Sign Group</p> <p>1450 Oak Forest Drive • Onalaska, WI 54650 • 608-781-1450 2242 Mustang Way • Madison, WI 53718 • 608-222-6353 2502 Melby Street • Eau Claire, WI 54703 • 715-835-6189</p>	Drawing by: Danielle Hadley	Job Name: Kwik Trip	Revision Number:	1	PPG NA 208400	7	<input type="checkbox"/>
	Sign Type: Monument	Job Address:	Job File Location:	2	Black S/G paint	8	<input type="checkbox"/>
	Date Created: 10/7/2018	Salesperson: Cindy Bluske		3	NA 208080 Beige	9	<input type="checkbox"/>
	Last Modified: 3/28/2019	Job Number: 102023		4	#2283 Red Acrylic	10	<input type="checkbox"/>
Scale: 3/8" = 1' 0"				5	White of Acrylic	11	<input type="checkbox"/>
				6	Black (230-22)	12	<input type="checkbox"/>

SITE IMPROVEMENT PLANS FOR:

KWIK STAR #1089
POLK CITY, IA

SITE LOCATION MAP:

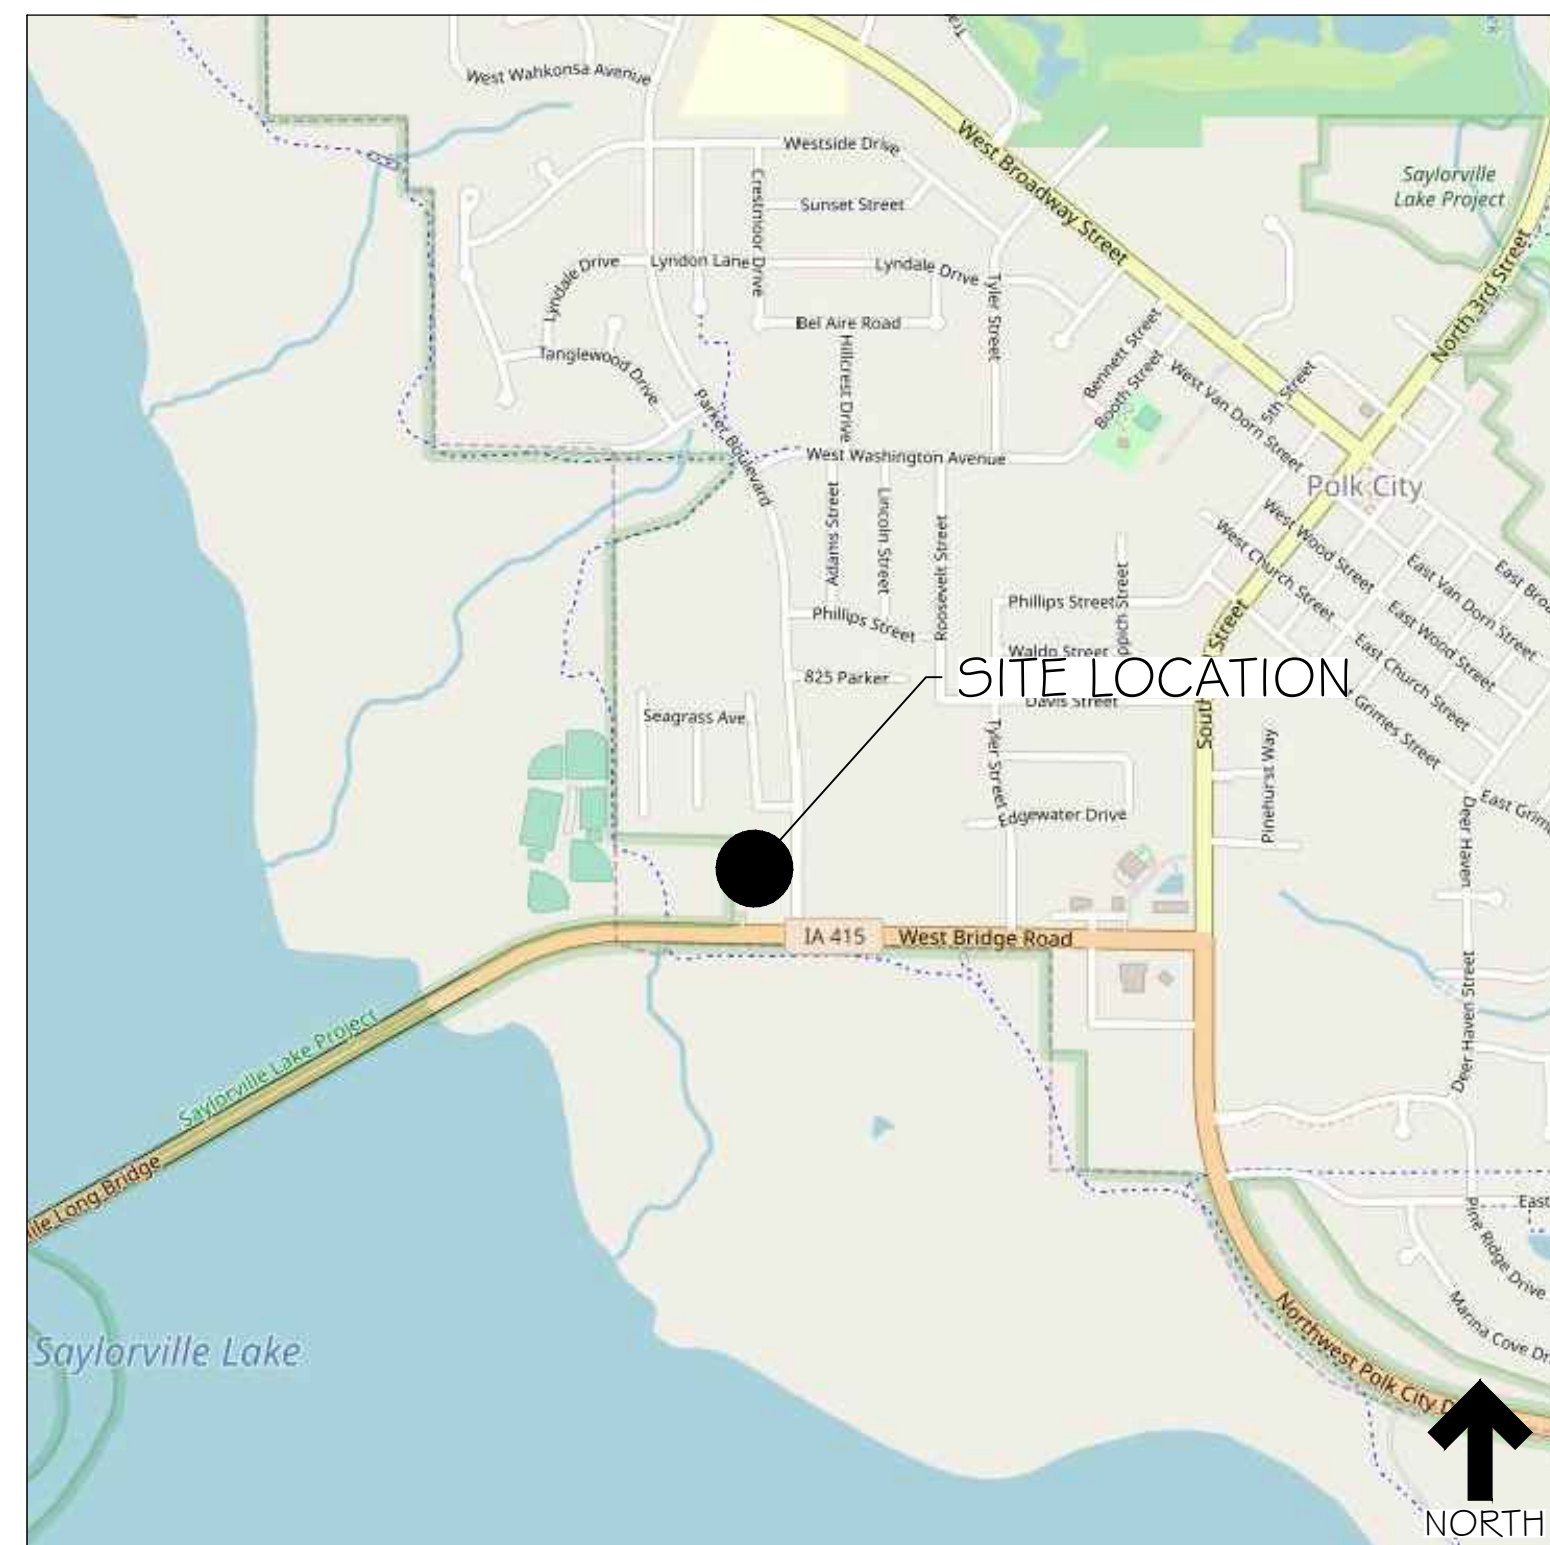

SITE AERIAL MAP:



DRAWING INDEX	
T 1	TITLE SHEET
SP0	SITE CIRCULATION PLAN
SP1	SITE DIMENSION PLAN
SP1.1	SITE KEYNOTE PLAN
SP2	GRADE PLAN
SP3	STORM SEWER PLAN
SP3.1	STORM SEWER NOTES & DETAILS
SP4	UTILITY PLAN
SP4.1	UTILITY NOTES
SP5	SITE PLAN DETAILS
SP6	SITE PLAN DETAILS
SP7	SUDAS SITE PLAN DETAILS
L1	LANDSCAPE PLAN
E1	PHOTOMETRIC SITE PLAN

NOTES:

-TEMPORARY OR PERMANENT POSTER-STYLE SIGNS ADVERTISING PRODUCTS OR SALES SHALL NOT BE MOUNTED TO THE EXTERIOR WALLS OF THE C-STORE OR CAR WASH BUILDINGS, FENCES, TRASH ENCLOSURE, GASOLINE CANOPY SUPPORTS, OR SIMILAR EXTERIOR LOCATIONS.

-TEMPORARY OR PERMANENT SIGNS DISPLAYED UNDER THE PUMP CANOPIES OR ON PUMP DISPENSERS SHALL HAVE LETTERS NO TALLER THAN 4 INCHES AND EACH SIGN SHALL HAVE A TOTAL SIGN AREA NO GREATER THAN 2 SQUARE FEET.

-A RAPID-ENTRY LOCK BOX SHALL BE INSTALLED ON THE BUILDING, WITH THE MODEL AND LOCATION ARE SUBJECT TO THE APPROVAL OF THE FIRE CHIEF.

-CAR WASH WILL BE OPERABLE BETWEEN THE HOURS OF 7AM AND 10PM IN ACCORDANCE WITH POLK CITY NOISE CONTROL ORDINANCE.

PROPERTY DESCRIPTION:
LOT 1 OF KWIK TRIP 1089, IN POLK CITY VENTURE, AN OFFICIAL PLAT, NOW INCLUDED IN AND FORMING A PART OF THE CITY OF POLK CITY, POLK COUNTY, IOWA.

AREA SUMMARY:
4.41 ACRES (191,933 S.F.)

ZONING:
C-2 COMMERCIAL DISTRICT

OUTDOOR MERCHANDISE:
There shall be no outdoor sales or storage on site, other than the outdoor merchandising area, ice merchandiser, propane exchange, firewood merchandising area, and screened delivery 'tote' storage shown on the approved site plan.

**KWIK
TRIP**

**KWIK
STAR**

KWIK TRIP, Inc.
P.O. BOX 2107
1626 OAK STREET
LACROSSE, WI 54602-2107
PH. (608) 781-8988
FAX (608) 781-8960



TITLE SHEET

CONVENIENCE STORE 1089

POLK CITY, IOWA

NO.	DATE	DESCRIPTION
19AUG19		SUBMITTAL
23SEP19		COMMENTS
22NOV19		SITE SHIFT/ APPROACHES
06JAN20		SUBMITTAL
23JAN20		CANOPY LAYOUT
25FEB20		COMMENTS
15MAR20		SIGN LOCATION
03JUN20		COMMENTS
10JUN20		9JUN20 COMMENTS

DRAWN BY	GRAPHIC
SCALE	
PROJ. NO.	191089
DATE	26JULY2019
SHEET	T1

OWNER:
KWIK TRIP INC.
1626 OAK STREET
LA CROSSE, WI 54602
SCOTT ZIETLOW
(608)793-5933
SJZietlow@kwiktrip.com


SITE PLANNER:
INSITES SITE PLANNING
3030 HARBOR LN N, SUITE 131
PLYMOUTH, MN 55447
BOB MUELLER
763-383-8400
Bob@InsitesInc.net

CIVIL ENGINEER:
SUNDE ENGINEERING
10830 NESBITT AVE SOUTH
BLOOMINGTON, MN 55437
(952)881-3344


ARCHITECT:
VANTAGE ARCHITECTS
750 3RD ST N, SUITE F
LA CROSSE, WI 54601
(608)784-2729

SURVEYOR:
SNYDER & ASSOCIATES
2727 S.W. SNYDER BLVD.
ANKENY, IA 50023
(515) 964-2020

INSITES 19.07.18 PM 5.7

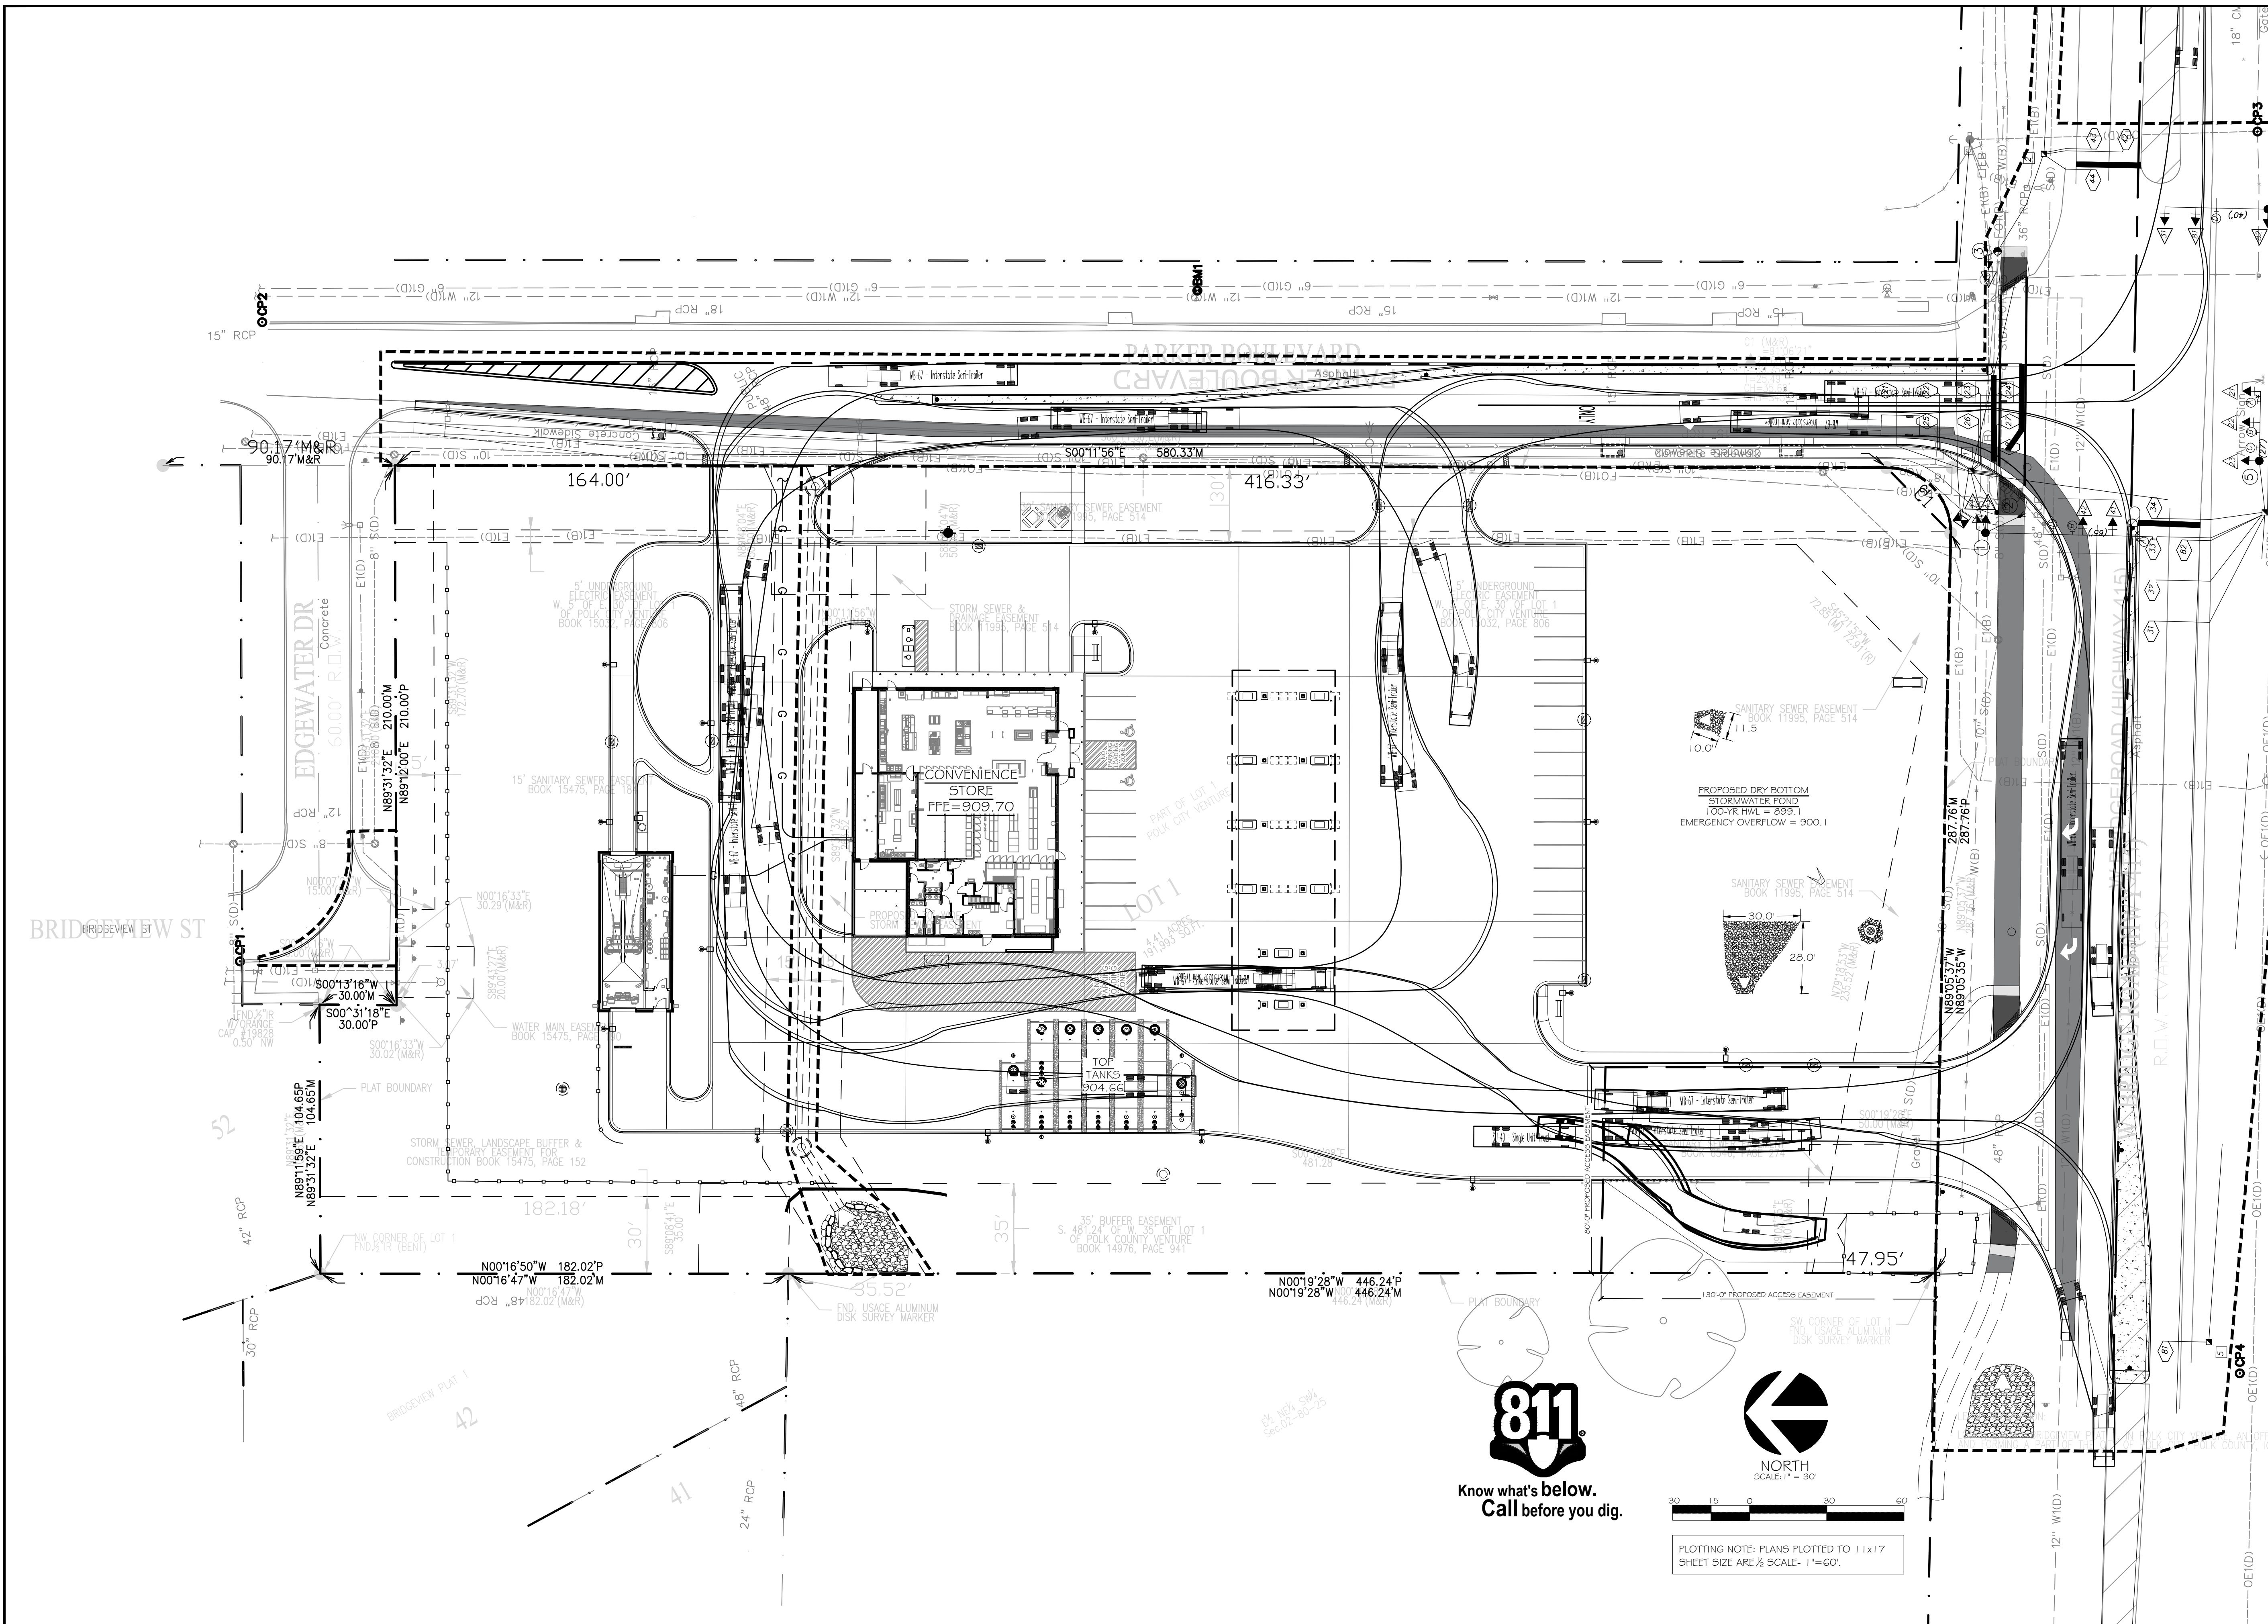

BRIDGEVIEW ST

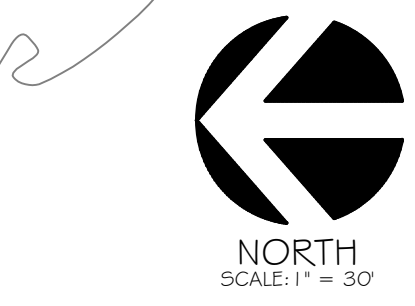


PLOTTING NOTE: PLANS PLOTTED TO 11x17 SHEET SIZE ARE 1/2 SCALE. 1"=60'.

Kwik Trip

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INSITES
 SITE PLANNING LANDSCAPE ARCHITECTURE
 3131 Fernbrook Lane North, STE 260
 Plymouth Minnesota 55447
 763.383.8400
 Fax 763.383.8400



SITE CIRCULATION PLAN

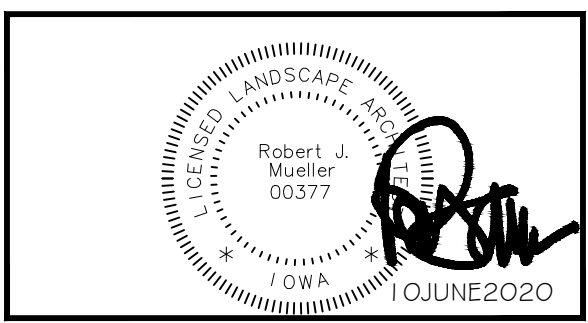CONVENIENCE STORE 1089

POLK CITY, IOWA

NO.	DATE	DESCRIPTION
19AUG19	19AUG19	SUBMITTAL
23SEP19	23SEP19	COMMENTS
22NOV19	22NOV19	SITE SHIFT/ APPROACHES
02JAN20	02JAN20	SUBMITTAL
23JAN20	23JAN20	CANOPY LAYOUT
25FEB20	25FEB20	COMMENTS
15MAR20	15MAR20	SIGN LOCATION
03JUN20	03JUN20	COMMENTS
10JUN20	10JUN20	COMMENTS

DRAWN BY: _____

SCALE: _____ GRAPHIC

PROJ. NO.: 191089

DATE: 26JULY2019

SHEET: **SP0**


INSITES 19.01.18 PM 5.7

Kwik Trip

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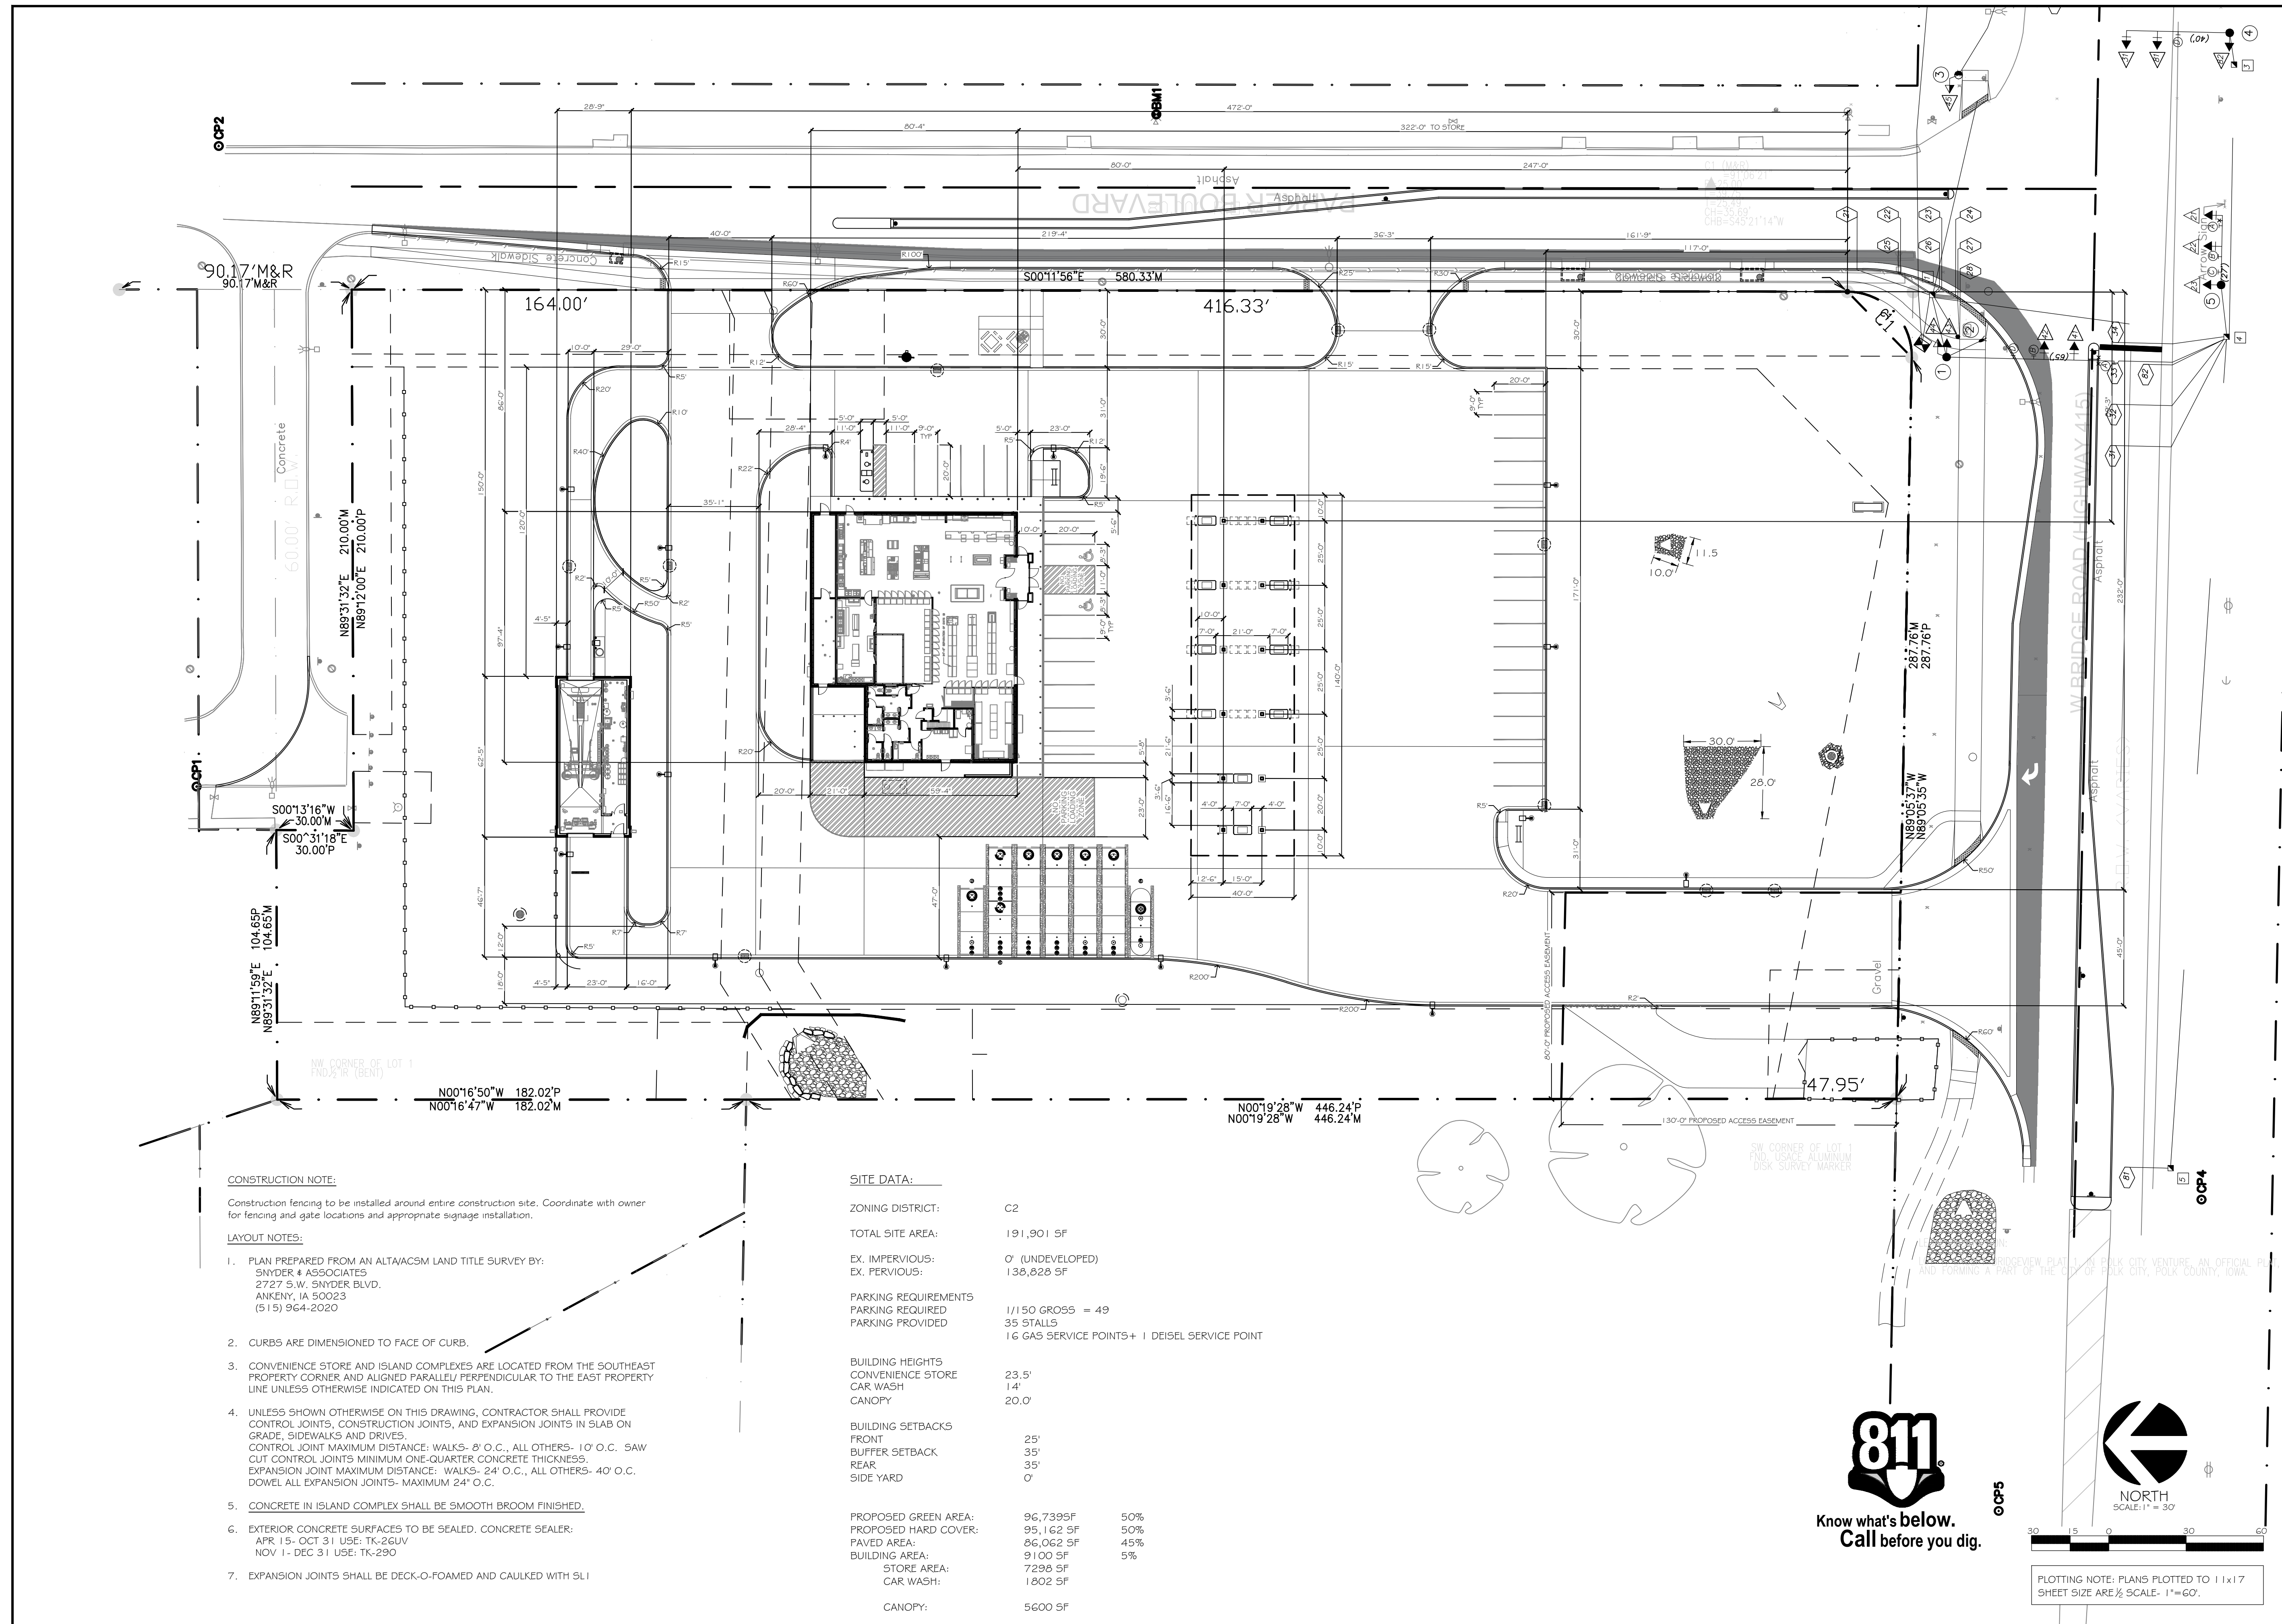
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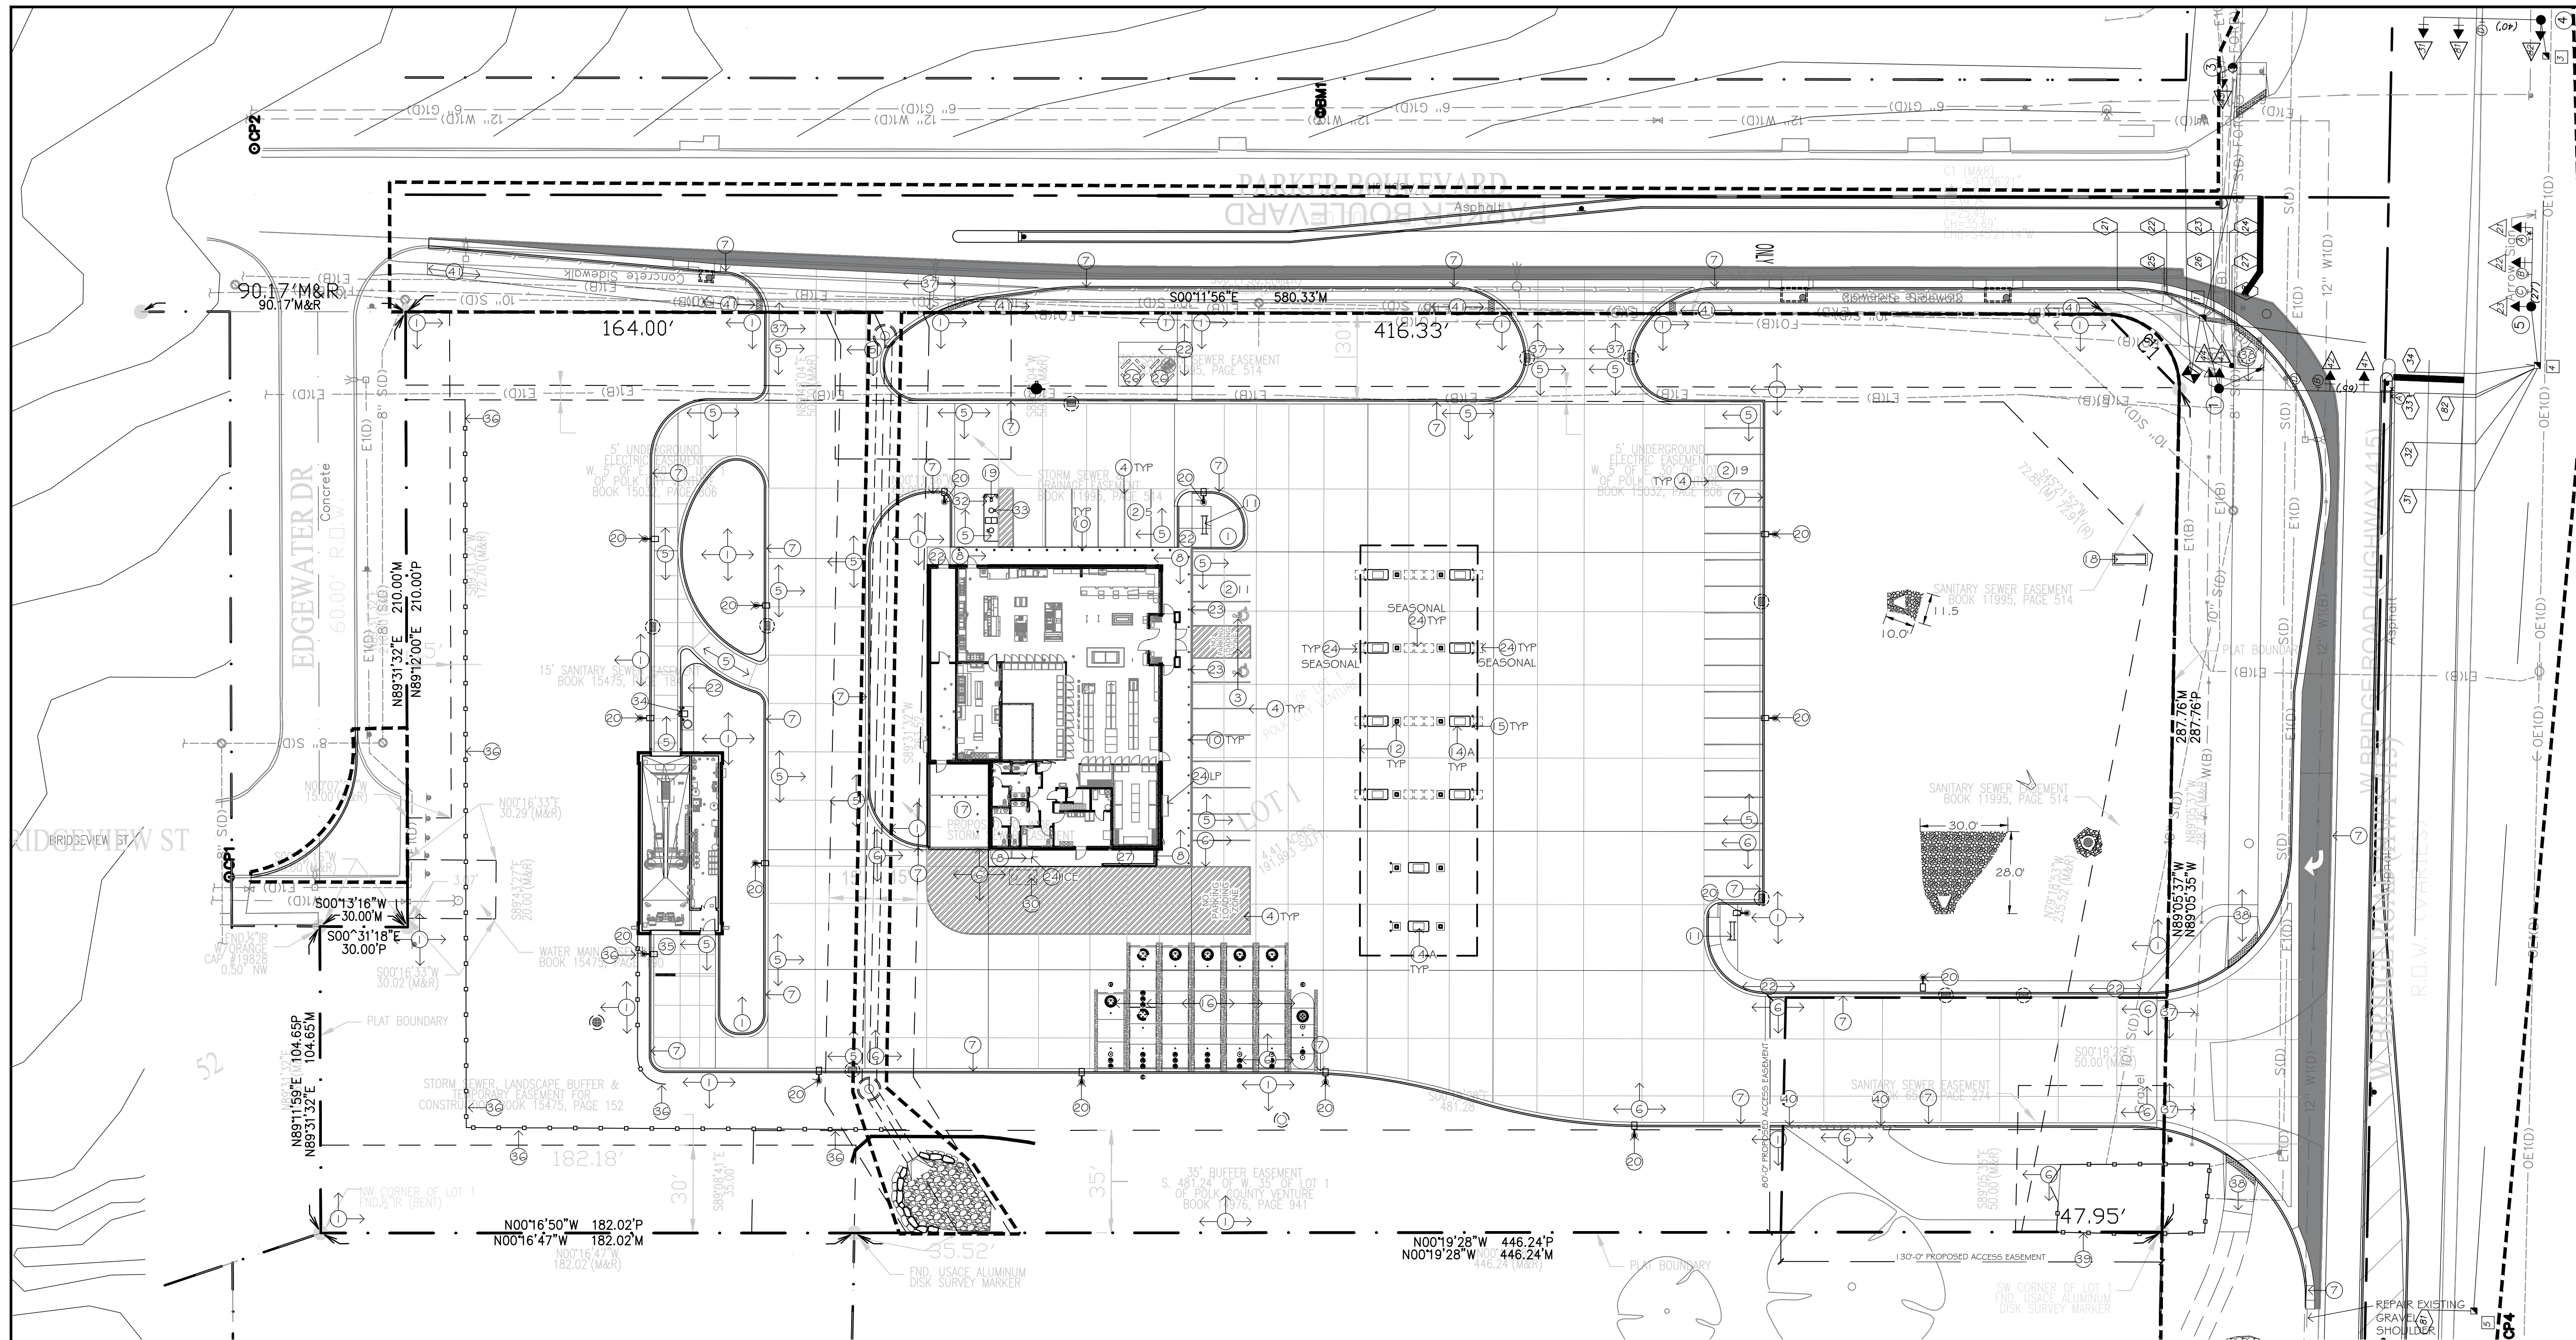
SITE DIMENSION PLAN
CONVENIENCE STORE 1089
POLK CITY, IOWA

NO.	DATE	DESCRIPTION
19	08/21/19	SUBMITTAL
23	09/19/19	COMMENTS
22	11/19/19	SITE SHIFT APPROACHES
02	12/20/19	SUBMITTAL
23	12/20/19	CANOPY LAYOUT
25	02/20/20	COMMENTS
1	03/10/20	SIGN LOCATION
03	06/20/20	COMMENTS
1	06/20/20	COMMENTS

DRAWN BY: _____
 SCALE: _____ GRAPHIC
 PROJ. NO.: 191089
 DATE: 26JULY2019
 SHEET: **SP1**

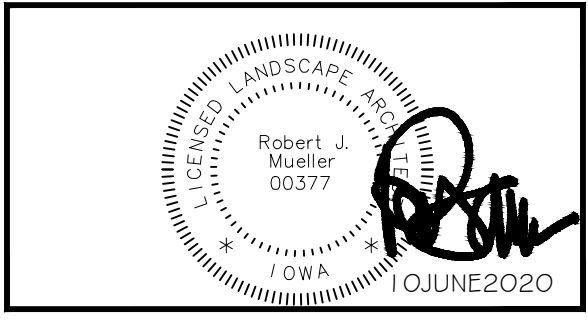

INSITES 19.01.18 PM 5:21



SITE PLAN KEYNOTES

1. LANDSCAPE AREA. SEE SHEET L.1.
2. OFF-STREET PARKING STALLS STRIPING - 4' WIDE STALL LINES, USE HIGH VISIBILITY WHITE PAINT. SPACES PROVIDED:
(1) 6 MULTI-FUEL SERVICE POINTS
(2) DIESEL POINTS
(3) 9'-0" X 20'-0" (MIN.) GENERAL PARKING
(2) 8'-0" X 20'-0" ACCESSIBLE PARKING WITH
(1) 11'-0" X 20'-0" LOADING ZONE
(2) 11'-0" X 20'-0" STALLS AT VACUUM
3. A.D.A. ACCESSIBLE PARKING SPACE WITH LOADING ZONE. PROVIDE APPROPRIATE STRIPING AND PAVEMENT MARKINGS.
4. 4' WIDE, HIGH VISIBILITY, PAVEMENT STRIPING, LANE MARKINGS AND TEXT. COLOR: HC MARKINGS- BLUE, ALL OTHERS- YELLOW.
5. 6" DEPTH (MIN.) CONCRETE SLAB-ON-GRADE WITH #3 REBAR, 3' O.C. CONCRETE SEALER: TK-26UV
6. 8" DEPTH (MIN.) CONCRETE SLAB-ON-GRADE WITH #4 REBAR, 3' O.C. CONCRETE SEALER: TK-26UV
7. B6-12 CONCRETE CURB AND GUTTER PER DETAIL 11/SP5.
8. 6" INTEGRAL CONCRETE CURB WALK. SEE DETAIL 7/SP5 FOR NON-FLUSH SECTIONS. CONCRETE SEALER: TK-26UV

9. STORM STRUCTURE. SEE SHEETS SP2-SP4.1, SP6 FOR FURTHER STORM SEWER INFORMATION.
10. 30" HT., 6" DIA. CONCRETE FILLED PIPE BOLLARD PER DETAIL 9/SP5.
11. 8 STALL BIKE RACK WITH 4" CONCRETE PAD (BRP 300 TRADITIONAL BIKE RACK-SINGLE SIDE PORTABLE SURFACE MOUNT ENDS FUSION COATINGS - A DIVISION OF RTM INC. TO BE PROVIDED BY OWNER)
12. 40'-0" X 140'-0" DISPENSER ISLAND CANOPY (5600 SF). VERIFY SIZE, PLACEMENT, COLUMN AND FOOTING SIZE WITH CANOPY AND STRUCTURAL PLANS. CANOPY GRAPHICS PER OWNER.
13. 24'-0" X 50'-0" COMMERCIAL DIESEL DISPENSER ISLAND CANOPY. VERIFY SIZE, PLACEMENT, COLUMN AND FOOTING SIZE WITH CANOPY AND STRUCTURAL PLANS. CANOPY GRAPHICS PER OWNER.
14. CONCRETE ISLANDS W/ 6" EXPOSURE WITH FUEL DISPENSERS. DISPENSER PER OWNER.
A. 3'-6" X 7'-0"
B. 3'-6" X 8'-0"
15. 36" HT., 6" DIA. CONCRETE FILLED PIPE BOLLARD PER DETAIL 8/SP5.
16. UNDERGROUND FUEL STORAGE TANKS PER OWNER. PROVIDE PIPING AND VENTING PER OWNER'S SPECIFICATIONS.
17. EXTERNAL TRASH ENCLOSURE TO MATCH BUILDING. SEE ARCHITECTURAL DETAILS.
18. KWIK TRIP TRADEMARK SIGN (VERIFY LOCATION WITH SIGN PERMIT)
19. "FREE AIR" COMPRESSOR. PROVIDE SIGNAGE PER OWNER.

20. SITE AREA LIGHT WITH CONCRETE BASE PER DETAIL 12/SP5.
21. PVC IRRIGATION SLEEVE UNDER PAVEMENT. VERIFY W/ IRRIGATION PLAN FOR EXACT SIZE AND LOCATION BEFORE INSTALLATION.
22. 4" DEPTH CONCRETE WALK PER DETAIL 3/SP5
23. HC PVC COLLAR SLEEVE PER OWNER. VAN ACCESS SIGNAGE AT 48" HT. STALL PARKING AT 60" HT.
24. OUTDOOR MERCHANDISING AREA
25. 84" HT., 6" DIA. CONCRETE FILLED PIPE BOLLARD PER DETAIL 6/SP5.
26. PICNIC TABLE PER OWNER. PROVIDE 1 HC. ACCESS TABLE SPACE. PROVIDE TRASH CONTAINER PER OWNER.
27. EXTERIOR DELIVERY TOTE STORAGE WITH SCREEN WALL
28. ELECTRICAL TRANSFORMER
29. ELECTRIC CAR CHARGER
30. GREASE INTERCEPTOR
31. POLE-MOUNTED AREA CAMERA WITH CONCRETE BASE PER DETAIL 12/SP5
32. CONCRETE CURB ISLAND
33. VACUUM PER MANUFACTURER'S SPECIFICATIONS. SEE DETAIL 2/SP5.
34. CAR WASH KEY PADY CONTROLLER. PROVIDE TRASH CONTAINER
35. 6" CONCRETE PAD WITH SNOW MELT PER MECHANICAL PLANS

36. 6' HT SCREEN FENCE
37. APPROACH PER SUDAS
38. BIKE PATH
39. LIFT STATION FENCE- BLACK POWDER-COATED STEEL WITH MATCHING 12" WIDE DOUBLE-LEAF GATE INSTALLED BY OWNER, MAINTAINED BY CITY. COORDINATE WITH CITY PUBLIC WORKS
40. MOUNTABLE CONCRETE CURB
41. PUBLIC SIDEWALK PER SUDAS



Know what's below.
Call before you dig.




PLOTTING NOTE: PLANS PLOTTED TO 11x17 SHEET SIZE ARE 1/2" SCALE- 1"=60'.

Kwik Trip

Kwik Star

KWIK TRIP, Inc.
P.O. BOX 2107
1626 OAK STREET
LACROSSE, WI 54602-2107
PH. (608) 781-8988
FAX (608) 781-8960

INSITES
SITE PLANNING LANDSCAPE ARCHITECTURE
3131 Fernbrook Lane North, STE 260
Plymouth Minnesota 55447
763.383.8400
Fax: 763.383.8400

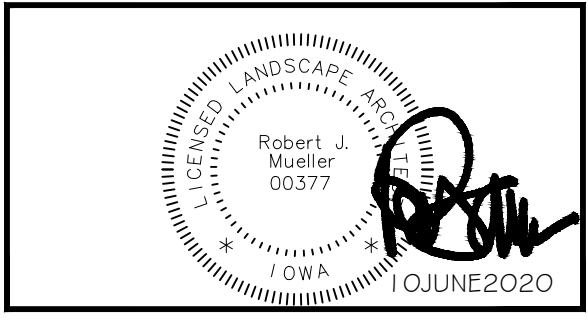

SITE KEYNOTE PLAN


CONVENIENCE STORE 1089

POLK CITY, IOWA

NO.	DATE	DESCRIPTION
19	12/19/21	SUBMITTAL
20	1/19/22	COMMENTS
21	2/23/22	SITE SHIFT APPROACHES
22	3/10/22	SUBMITTAL
23	3/23/22	CANOPY LAYOUT
24	3/25/22	COMMENTS
25	3/25/22	SIGN LOCATION
26	3/25/22	COMMENTS
27	6/10/22	COMMENTS

DRAWN BY	GRAPHIC
PROJ. NO.	191089
DATE	26JULY2019
SHEET	SP1.1

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NOTE: CONTRACTOR TO OBTAIN RIGHT-OF-WAY EXCAVATION PERMIT PRIOR TO BEGINNING SITE WORK.

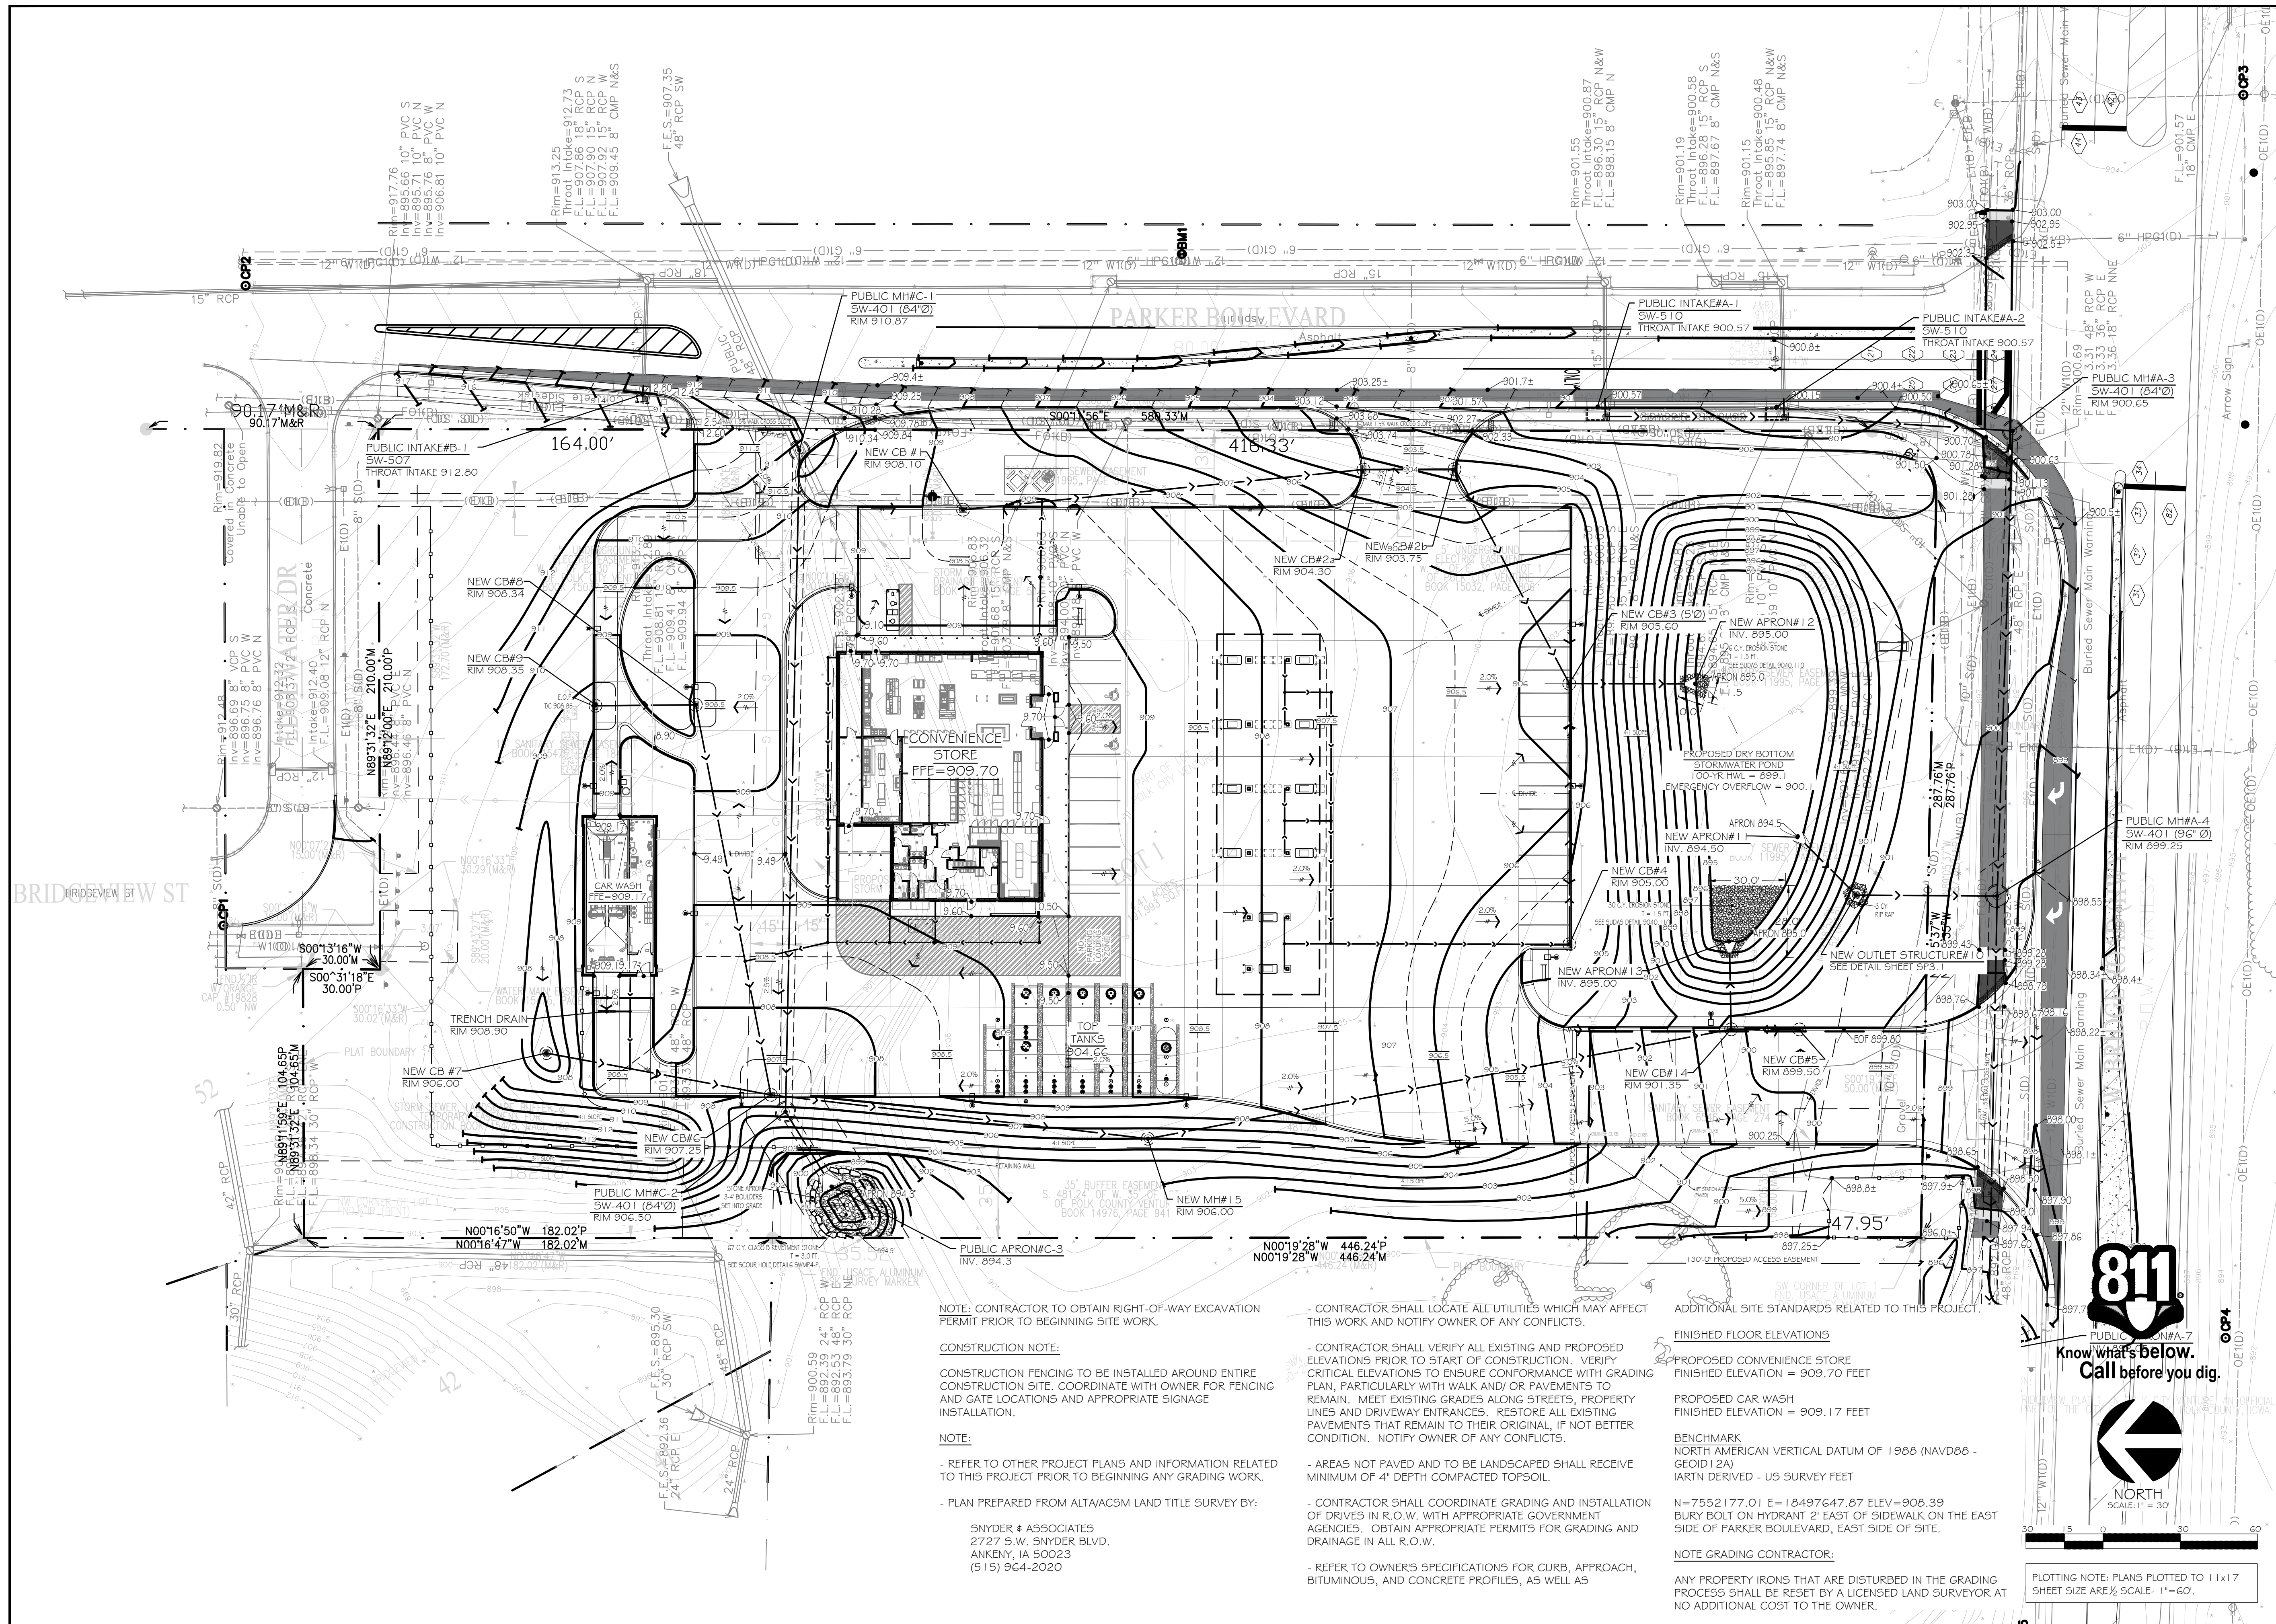CONSTRUCTION NOTE:
CONSTRUCTION FENCING TO BE INSTALLED AROUND ENTIRE CONSTRUCTION SITE. COORDINATE WITH OWNER FOR FENCING AND GATE LOCATIONS AND APPROPRIATE SIGNAGE INSTALLATION.

NOTE:
- REFER TO OTHER PROJECT PLANS AND INFORMATION RELATED TO THIS PROJECT PRIOR TO BEGINNING ANY GRADING WORK.
- PLAN PREPARED FROM ALTA/ACSM LAND TITLE SURVEY BY:
SNYDER & ASSOCIATES
2727 S.W. SNYDER BLVD.
ANKENY, IA 50023
(515) 964-2020

CONTRACTOR SHALL LOCATE ALL UTILITIES WHICH MAY AFFECT THIS WORK AND NOTIFY OWNER OF ANY CONFLICTS.

CONTRACTOR SHALL VERIFY ALL EXISTING AND PROPOSED ELEVATIONS PRIOR TO START OF CONSTRUCTION. VERIFY CRITICAL ELEVATIONS TO ENSURE CONFORMANCE WITH GRADING PLAN, PARTICULARLY WITH WALK AND/OR PAVEMENTS TO REMAIN. MEET EXISTING GRADES ALONG STREETS, PROPERTY LINES AND DRIVEWAY ENTRANCES. RESTORE ALL EXISTING PAVEMENTS THAT REMAIN TO THEIR ORIGINAL, IF NOT BETTER CONDITION. NOTIFY OWNER OF ANY CONFLICTS.

AREAS NOT PAVED AND TO BE LANDSCAPED SHALL RECEIVE MINIMUM OF 4" DEPTH COMPACTED TOPSOIL.

CONTRACTOR SHALL COORDINATE GRADING AND INSTALLATION OF DRIVES IN R.O.W. WITH APPROPRIATE GOVERNMENT AGENCIES. OBTAIN APPROPRIATE PERMITS FOR GRADING AND DRAINAGE IN ALL R.O.W.

REFER TO OWNER'S SPECIFICATIONS FOR CURB, APPROACH, BITUMINOUS, AND CONCRETE PROFILES, AS WELL AS

ADDITIONAL SITE STANDARDS RELATED TO THIS PROJECT:

FINISHED FLOOR ELEVATIONS
PROPOSED CONVENIENCE STORE
FINISHED ELEVATION = 909.70 FEET
PROPOSED CAR WASH
FINISHED ELEVATION = 909.17 FEET

BENCHMARK
NORTH AMERICAN VERTICAL DATUM OF 1988 (NAVD88 - GEOID12A)
IARTN DERIVED - U5 SURVEY FEET

NOTE GRADING CONTRACTOR:
ANY PROPERTY IRONS THAT ARE DISTURBED IN THE GRADING PROCESS SHALL BE RESET BY A LICENSED LAND SURVEYOR AT NO ADDITIONAL COST TO THE OWNER.

811
Know what's below.
Call before you dig.

NORTH
SCALE: 1" = 30'


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Kwik TRIP

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LACROSSE, WI 54602-2107
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INSITES
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3131 Fernbrook Lane North, STE 260
Plymouth Minnesota 55447
763.383.8400
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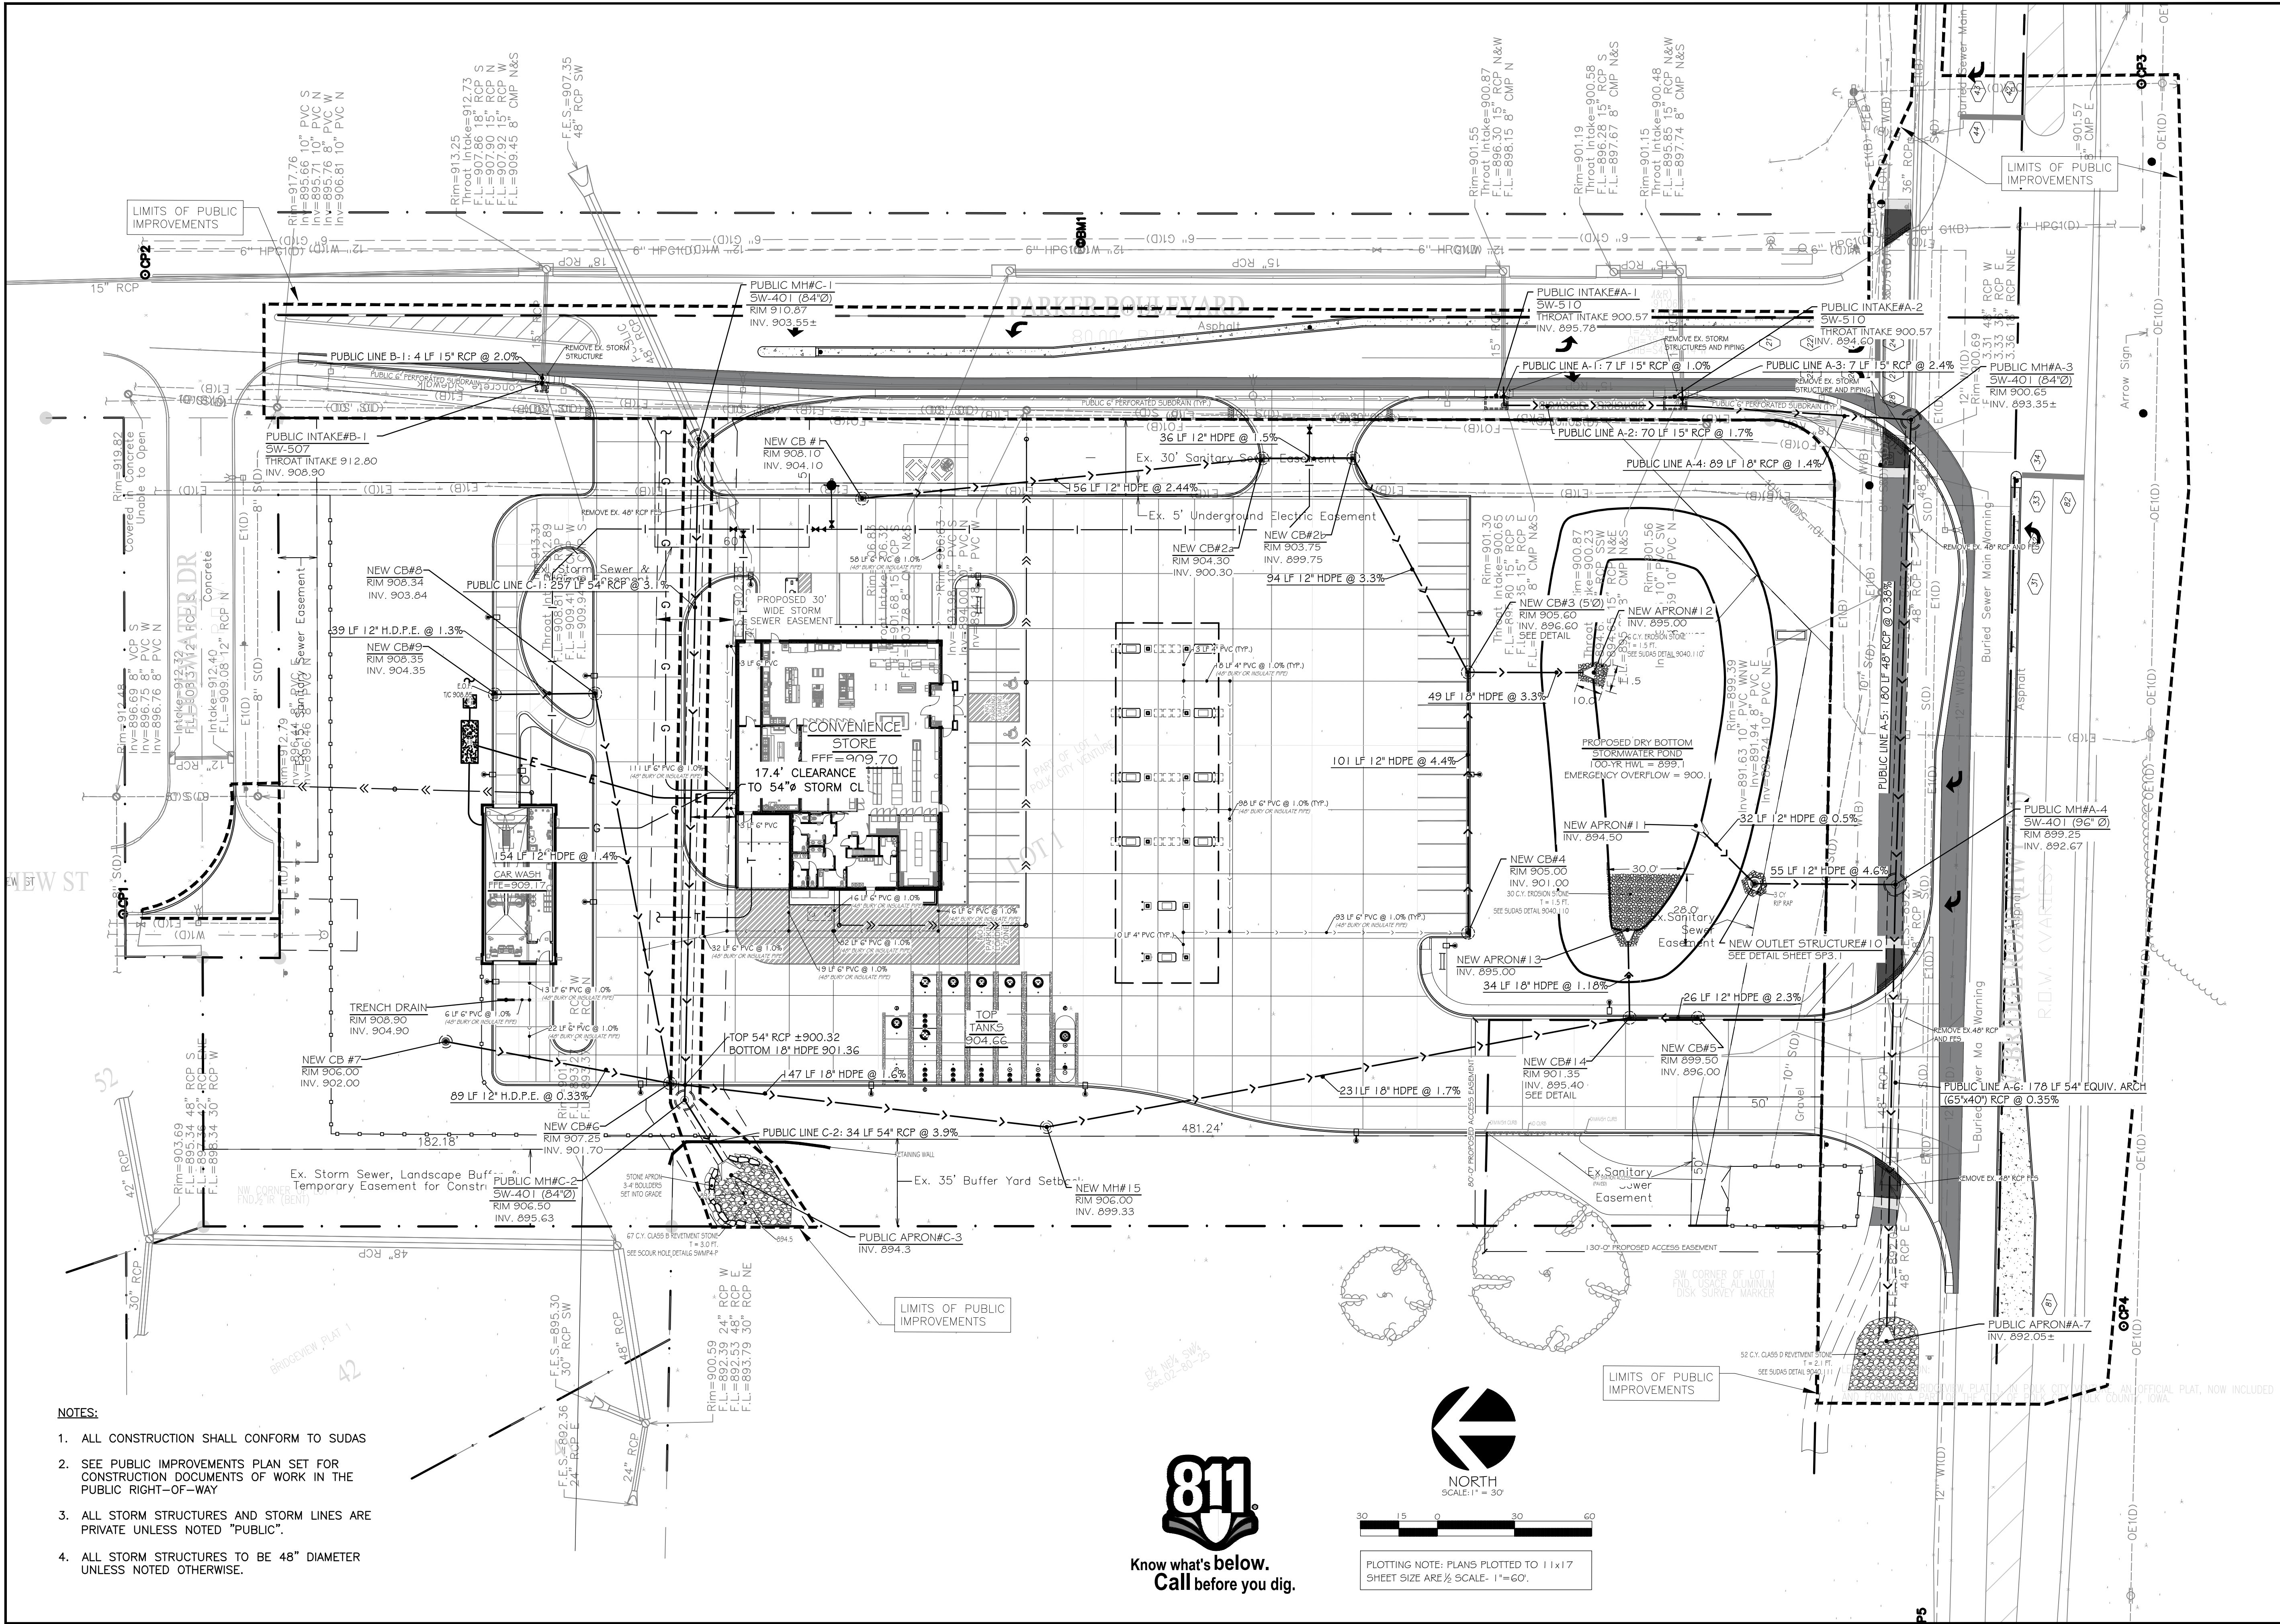
GRADE PLAN

CONVENIENCE STORE 1089


POLK CITY, IOWA

NO.	DATE	DESCRIPTION
19	02/19/21	SUBMITTAL COMMENTS
20	03/19/21	SITE SHIFT APPROACHES
21	04/19/21	SUBMITTAL COMMENTS
22	05/19/21	CANOPY LAYOUT
23	06/19/21	COMMENTS
24	07/19/21	SIGN LOCATION
25	08/19/21	COMMENTS
26	09/19/21	COMMENTS

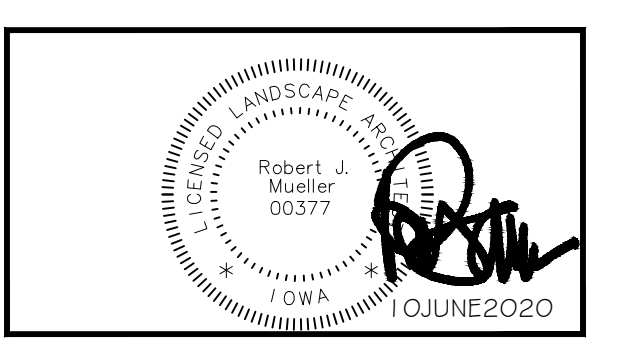DRAWN BY: _____ SCALE: GRAPHIC
 PROJ. NO.: 191089
 DATE: 26JULY2019
 SHEET: **SP2**





- NOTES:**
1. ALL CONSTRUCTION SHALL CONFORM TO SUDAS
 2. SEE PUBLIC IMPROVEMENTS PLAN SET FOR CONSTRUCTION DOCUMENTS OF WORK IN THE PUBLIC RIGHT-OF-WAY
 3. ALL STORM STRUCTURES AND STORM LINES ARE PRIVATE UNLESS NOTED "PUBLIC".
 4. ALL STORM STRUCTURES TO BE 48" DIAMETER UNLESS NOTED OTHERWISE.

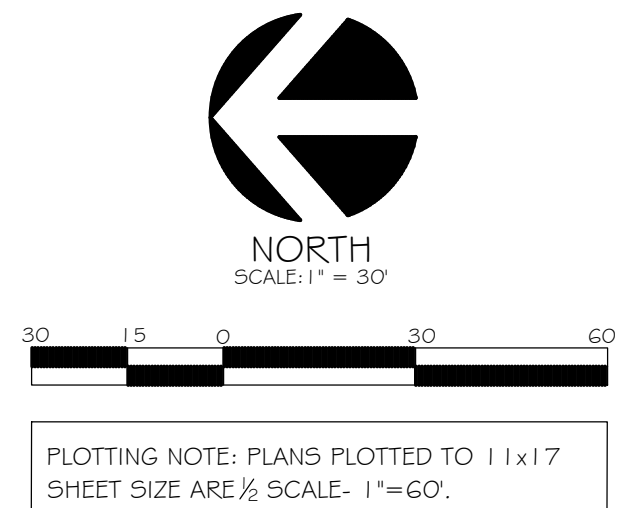

Kwik Trip

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 FAX (608) 781-8960

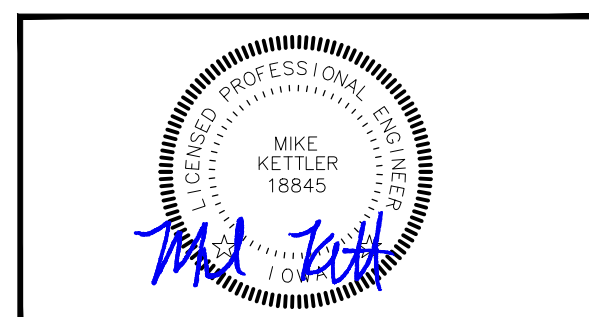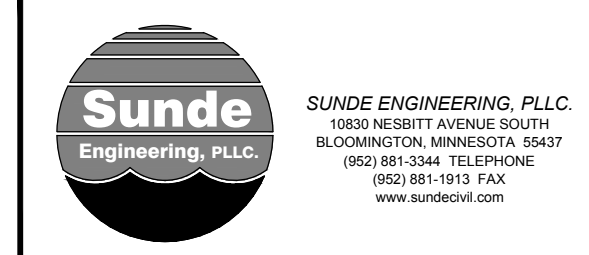

STORM SEWER PLAN
CONVENIENCE STORE 1089
 POLK CITY, IOWA


NO.	DATE	DESCRIPTION
19AUG19	19AUG19	SUBMITTAL
23SEP19	23SEP19	COMMENTS
22NOV19	22NOV19	SITE SHIRT APPROACHES
02JAN20	02JAN20	SUBMITTAL
23JAN20	23JAN20	CANOPY LAYOUT
25FEB20	25FEB20	COMMENTS
18MAR20	18MAR20	SIGN LOCATION
03JUN20	03JUN20	COMMENTS
10JUN20	10JUN20	COMMENTS

DRAWN BY: SCALE: GRAPHIC
 PROJ. NO.: 191089
 DATE: 26JULY2019
 SHEET: **SP3**

ISSUES 19-018 REV 5/2

STORM DRAINAGE :

- Unless otherwise indicated, use reinforced, precast, concrete maintenance holes and catchbasins conforming to ASTM C478, furnished with water stop rubber gaskets and precast bases. Joints for all precast maintenance hole sections shall have confined, rubber "O"-ring gaskets in accordance with ASTM C443. These joints are normally used in sewers to hold infiltration and exfiltration to a practical minimum and are adequate for hydrostatic heads up to 30'. The inside barrel diameter shall not be less than 48 inches. See SUDAS Std. SW-401 for circular storm sewer manholes and SUDAS Std. SW-502 for circular single grate intake catchbasins.
- Install catchbasin castings with specified top elevation at the front rim.
- All joints and connections in the storm sewer system shall be gastight or watertight. Joints between concrete structures and piping shall be made with mechanical joints. Use approved resilient rubber seals or waterstop gaskets in order to make watertight connections to manholes, catchbasins, and other structures in conformance with ASTM C923 or as otherwise permitted by the local authority. Cement mortar joints are permitted only for repairs or connections to existing lines having such joints, or unless otherwise permitted by the administrative authority.
- The building sewer starts 2 feet outside of the building. See Uniform Plumbing Code (UPC) part 715.1. Material installed within 2 feet of the building must be of materials approved for use inside of or within the building.
- PVC Pipe (Outside of the Building):** Use solid-core, SDR-35, ASTM D3034 Polyvinyl Chloride (PVC) Pipe for designated PVC storm sewer services 4 to 15-inches in diameter outside of the building. Use solid-core, SDR-35, ASTM F679 Polyvinyl Chloride (PVC) pipe for designated PVC storm sewer services 18 to 27-inches in diameter outside of the building. Joints for all storm sewer shall have push-on joints with elastomeric gaskets. Use of solvent cement joints is allowed for building services. Solvent cement joints in PVC pipe must include use of a primer which is of contrasting color to the pipe and cement in accordance with Uniform Plumbing Code (UPC), part 605.13.2. Pipe with solvent cement joints shall be joined with PVC cement conforming to ASTM D2564. Lay all PVC pipe on a continuous granular bed. Installation must comply with ASTM D2321.
- Cleanouts:** Install cleanouts on all roof drains. Cleanouts shall be installed at every wye, sweep, and bend. Install cleanouts on all storm sewer services in accordance with UPC part 719.0 and 1101.12. The distance between cleanouts in horizontal piping shall not exceed 100 feet for pipes 10-inches and under in size. Cleanouts shall be of the same nominal size as the pipes they serve. Install a meter box frame and solid lid (Neenah R-1914-A, or approved equal) over all cleanouts. Provide cleanouts at the base of the roof leader connections at the gas island pump stations.
- Fittings:** Provide directional fittings for the storm piping serving the gas island pump stations. All changes in direction of flow in drain piping shall be made by the appropriate use of 45 degree wyes, long or short sweep quarter bends, sixth, eighth, or sixteenth bends, or by a combination of these or other equivalent fittings.
- RCP:** Reinforced concrete pipe (RCP) and fittings shall conform to ASTM C76, Design C, with circular reinforcing for the class of pipe specified. Use Class IV RCP for pipes 21" and larger. Use Class V RCP for pipes 18" and smaller. Joints shall be made up of concrete surfaces with a groove on the spigot for an O-ring rubber gasket (also referred to as a confined O-ring type joint) in accordance with ASTM C361. These joints are normally used in gravity sewers where exceptional tightness is required. This type of joint provides excellent inherent water tightness in both the straight and deflected position and meets all the joint requirements of ASTM C443.
- RC Aprons:** Install a reinforced concrete apron on the free end of all daylighted RCP storm sewer pipes. Tie the last three sections (including apron) of all daylighted RCP storm sewer with a minimum of two tie bolt fasteners per joint. This requirement applies to both upstream and downstream pipe inlets and outlets. For concrete culverts, tie all joints. Ties to be used only to hold the pipe sections together, not for pulling the sections tight. Nuts and washers are not required on inside of 675 mm (27 inch) or less diameter pipes.
- Grates on horizontal pipes:** Install safety-trash grates on all horizontal inlets/outlets greater than 6 inches in diameter. The grates shall be placed so that the rods or bars are not more than 3 inches downstream of the inlet/outlet. Rods or bars shall be spaced so that the openings do not permit the passage of a 6-inch sphere.

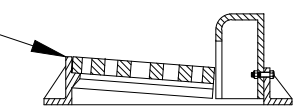

- Testing:** Test all portions of storm sewer that are within 10 feet of buildings, within 10 feet of buried water, lines, within 50 feet of water wells, or that pass through soil or water identified as being contaminated in accordance with UPC part 1109.0. Test all flexible storm sewer lines for deflection after the sewer line has been installed and backfill has been in place for at least 30 days. No pipe shall exceed a deflection of 5%. If the test fails, make necessary repairs and retest.
- Draintile:** Perforated under-drains shall be slotted single wall corrugated HDPE. Install draintile with high permittivity circular knit polymeric filament filter sock per ASTM D6707-01.
- Use SUDAS Std. SW-604 Type 5 ditch stool grate and frame, or approved equal, on CB #7.
- Use SUDAS Std. SW-603 Type R casting with curb inlet grate, or approved equal, on CB#1, CB#2a, CB#2b, CB#3, CB#4, CB#5, CB#6, CB#8, CB#9, and CB#14. Casting shall include the "NO DUMPING, DRAINS TO RIVER," environmental notice.
- Use SUDAS Std. SW-602 casting with self-sealing, solid, Type E lid, or approved equal, on all storm sewer maintenance holes. Covers shall bear the "Storm Sewer" label.
- Use Zurn Z886 trench drain model 8606N with black acid resistant epoxy coated ductile grate - Class C for proposed trench drain.
- Install detectable underground marking tape directly above all pvc, polyethylene, and other nonconductive underground utilities at a depth of 457 mm (18 inches) below finished grade, unless otherwise indicated. Bring the tape to the surface at various locations in order to provide connection points for locating underground utilities. Install green Rhino TriView Flex Test Stations, or approved equal, with black caps at each surface location.
- The minimum depth of cover for building and canopy roof drain leaders without insulation is 3 feet. Insulate roof drain leaders at locations where the depth of cover is less than 5 feet. Provide a minimum insulation thickness of 2 inches. The insulation must be at least 4 feet wide and centered on the pipe. Install the insulation boards 6 inches above the tops of the pipes on mechanically compacted and leveled pipe bedding material. Use high density, closed cell, rigid board material equivalent to DOW Styrofoam HI-40 plastic foam insulation.
- Install all pipe with the ASTM identification numbers on the top for inspection. Commence pipe laying at the lowest point in the proposed sewer line. Lay the pipe with the bell end or receiving groove end of the pipe pointing upgrade. When connecting to an existing pipe, uncover the existing pipe in order to allow any adjustments in the proposed line and grade before laying any pipe. Do not lay pipes in water or when the trench conditions are unsuitable for such work.
- Line ponds with 2" thick impervious clay liner per detail.
- Clean sediment and debris from sewers, sumps and stormwater basins prior to final owner acceptance.
- Televise all existing lines prior to connection.
- Provide a final storm water management report that will serve to verify that the intent of the approved storm water management design has been met. The report shall include record drawings, measurements, and photographic evidence of the as-built storm water management system. The report shall substantiate that all aspects of the original design have been adequately provided for by the construction of the project.
- Fittings:** Provide directional fittings for the storm piping serving the gas island pump stations. All changes in direction of flow in drain piping shall be made by the appropriate use of 45 degree wyes, long or short sweep quarter bends, sixth, eighth, or sixteenth bends, or by a combination of these or other equivalent fittings.
- Install finger drains at each and every proposed catchbasin (see detail). Finger drains around catch basin inlets shall not be installed below the crown of the storm drain piping.

HDPE REQUIREMENTS :




- Install dual-wall, smooth interior, corrugated high-density polyethylene (HDPE) pipe at locations indicated on the plan. High-density polyethylene (HDPE) storm sewers must meet ASTM F714.
- Dual-wall, smooth interior, corrugated high-density polyethylene (HDPE) pipe shall conform to the requirements of AASHTO M252 for pipe sizes 4-inch to 10-inch diameter. Dual-wall, smooth interior, corrugated high-density polyethylene (HDPE) pipe shall conform to the requirements of ASTM F2306 (virgin PE material) for pipe sizes 12-inch to 60-inch diameter.
- All fittings must comply with ASTM Standard D3212.
- Water-tight joints must be used at all connections (including structures) in conformance with ASTM F2510.**
- HDPE pipe connections into all concrete structures must be made with water tight materials utilizing Nyoplast "Manhole Adaptors" along with Press-Seal or Kor-N-Seal "Watertight Connector", Cast-A-Seal "Precast Watertight Connector", or approved equals. Where the alignment precludes the use of the above approved watertight methods, Conseal 231 WaterStop sealant, or approved equal will only be allowed as approved by the Administrative Authority.
- Lay all HDPE pipe on a continuous granular bed. Installation must comply with ASTM D2321. All sections of the corrugated HDPE pipe shall be coupled in order to provide water-tight joints.
- Perform deflection tests on all HDPE pipe after the sewer lines have been installed and backfill has been in place for at least 30 days. No pipe shall exceed a deflection of 5%. If the test fails, make necessary repairs and perform the test again until acceptable. Supply the mandrel for deflection testing. If the deflection test is to be run using a rigid ball or mandrel, it shall have a diameter equal to 95% of the inside diameter of the pipe. The ball or mandrel shall be clearly stamped with the diameter. Perform the tests without mechanical pulling devices.

ALL CONSTRUCTION SHALL CONFORM TO SUDAS


KWIK TRIP

KWIK STAR


KWIK TRIP, Inc.
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LACROSSE, WI 54602-2107
PH. (608) 781-8988
FAX (608) 781-8960

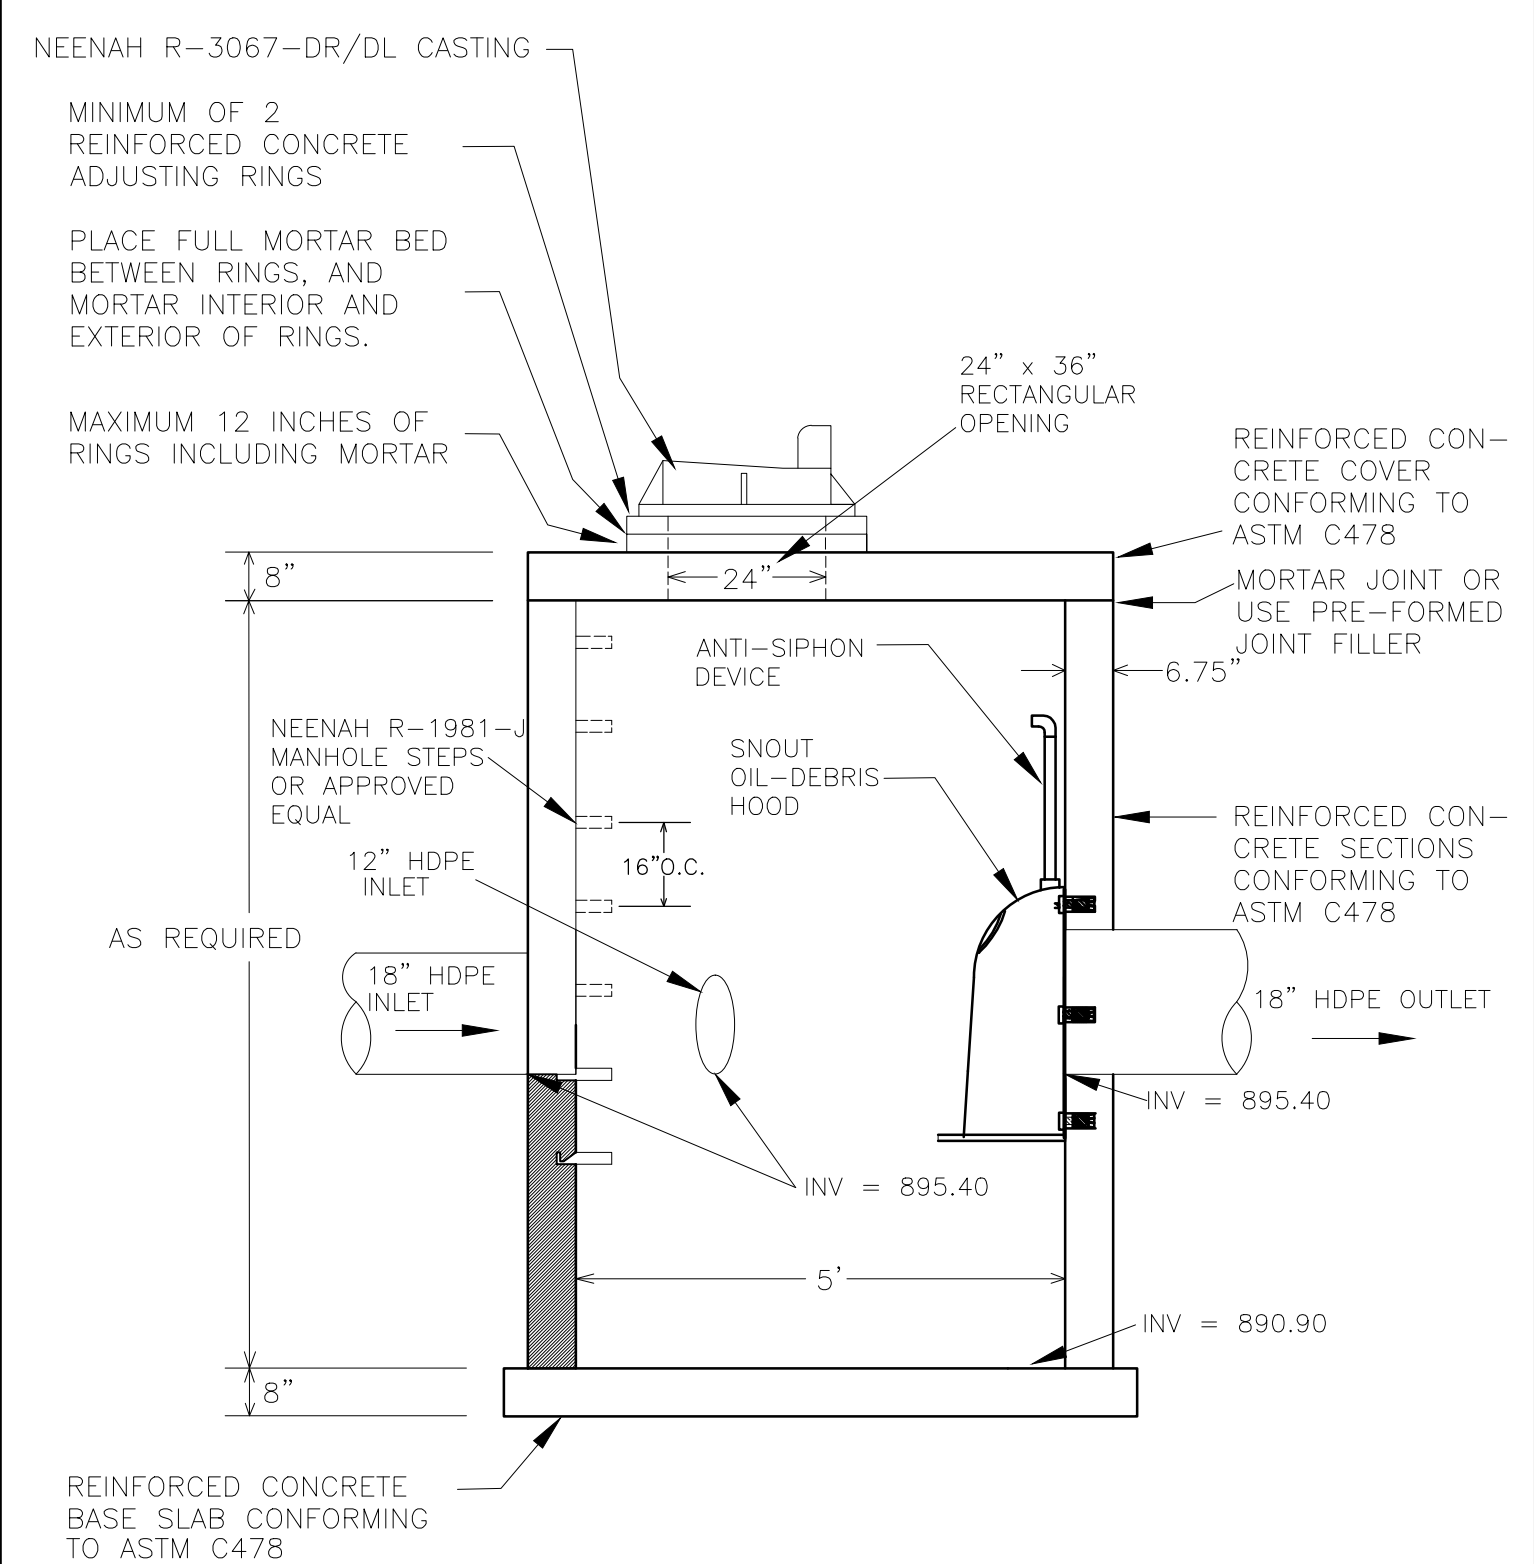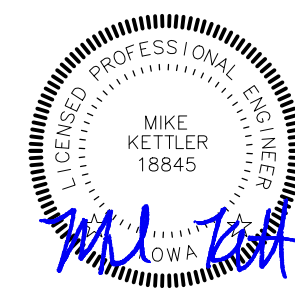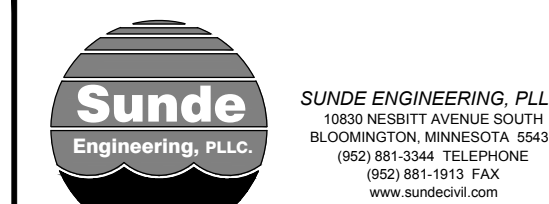

OIL SKIMMER CB #14

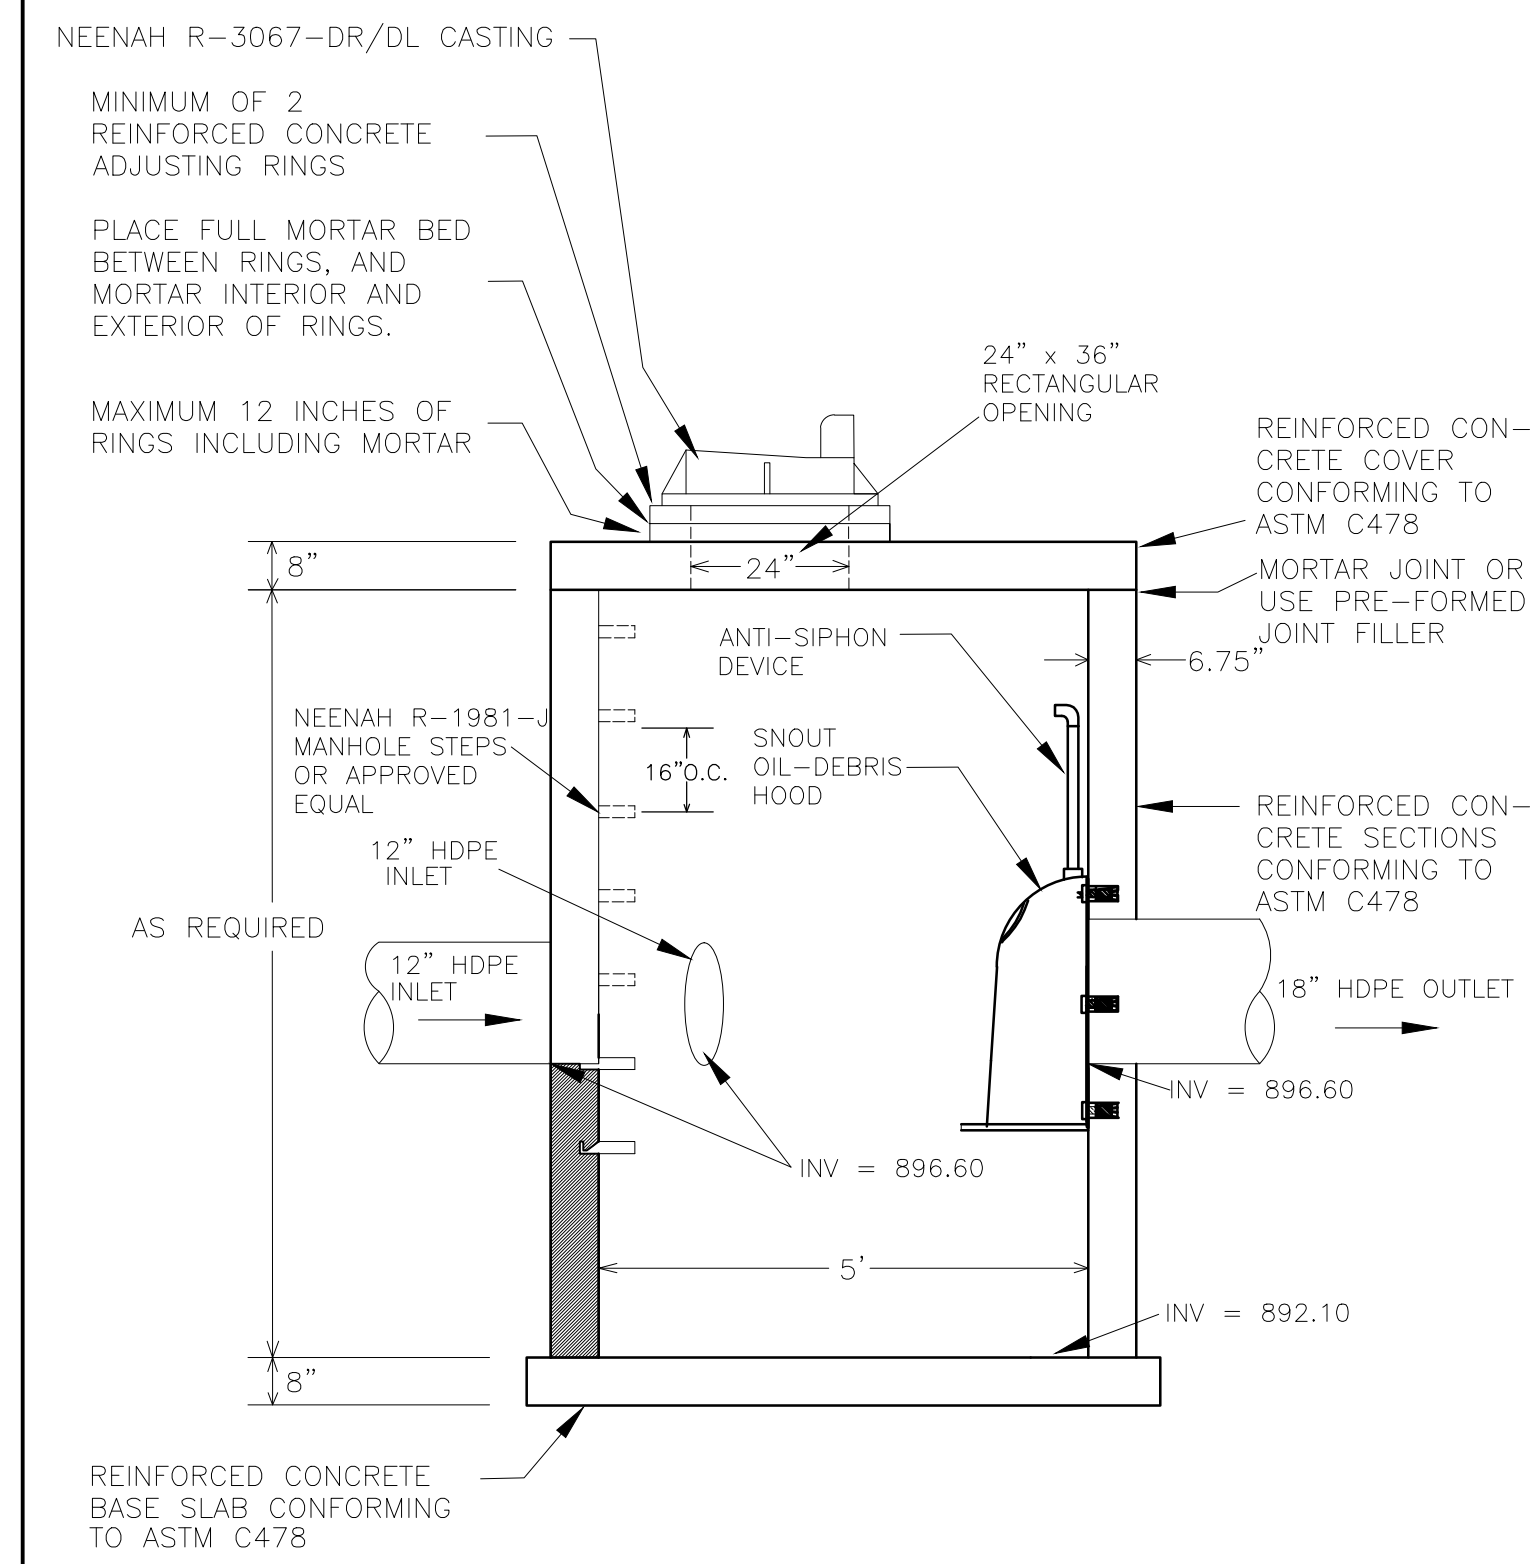

OIL SKIMMER CB #3

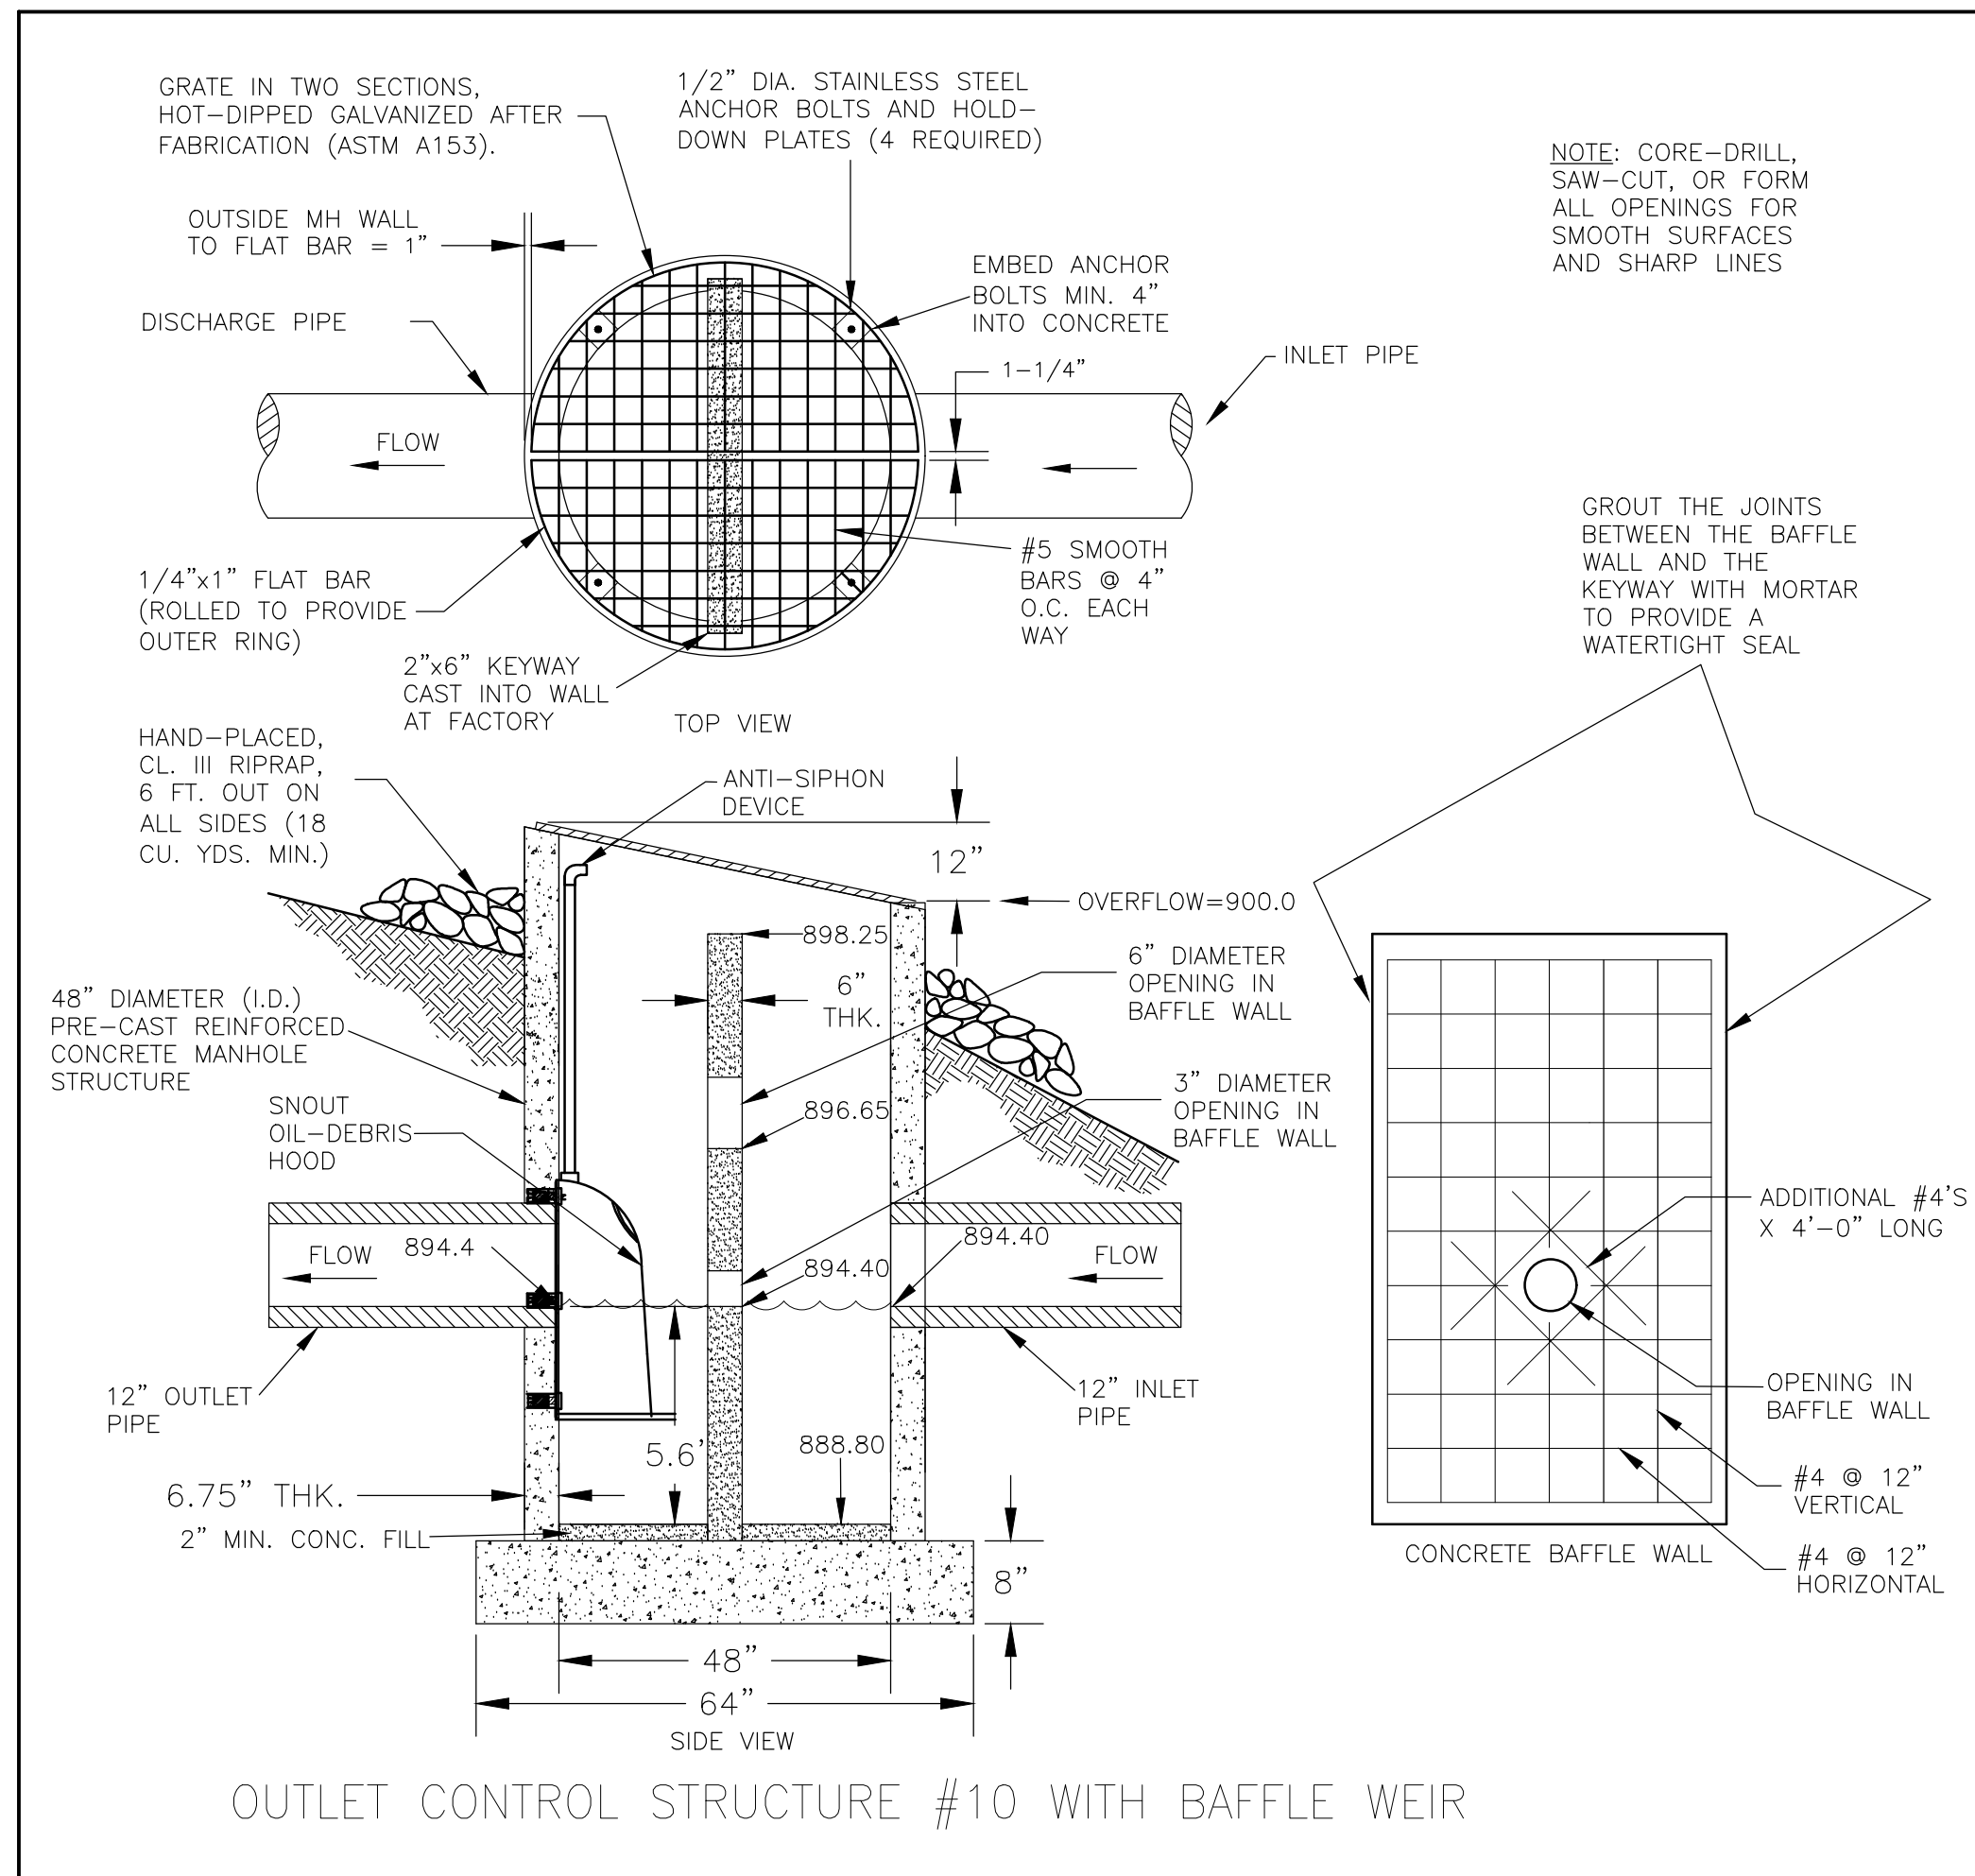

OUTLET CONTROL STRUCTURE #10 WITH BAFFLE WEIR

STORM NOTES AND DETAILS

CONVENIENCE STORE 1089

POLK CITY, IOWA

NO.	DATE	DESCRIPTION
19AUG19	19AUG19	SUBMITTAL
23SEP19	23SEP19	COMMENTS
22NOV19	22NOV19	SITE SHIRT APPROACHES
06JAN20	06JAN20	SUBMITTAL
23JAN20	23JAN20	CANOPY LAYOUT
25FEB20	25FEB20	COMMENTS
18MAR20	18MAR20	SIGN LOCATION
03JUN20	03JUN20	COMMENTS
10JUN20	10JUN20	SUNING COMMENTS

DRAWN BY _____


SCALE _____ GRAPHIC

PROJ. NO. 191089

DATE 26JULY2019

SHEET **SP3.1**

SHEET 19-018 REV 5/2

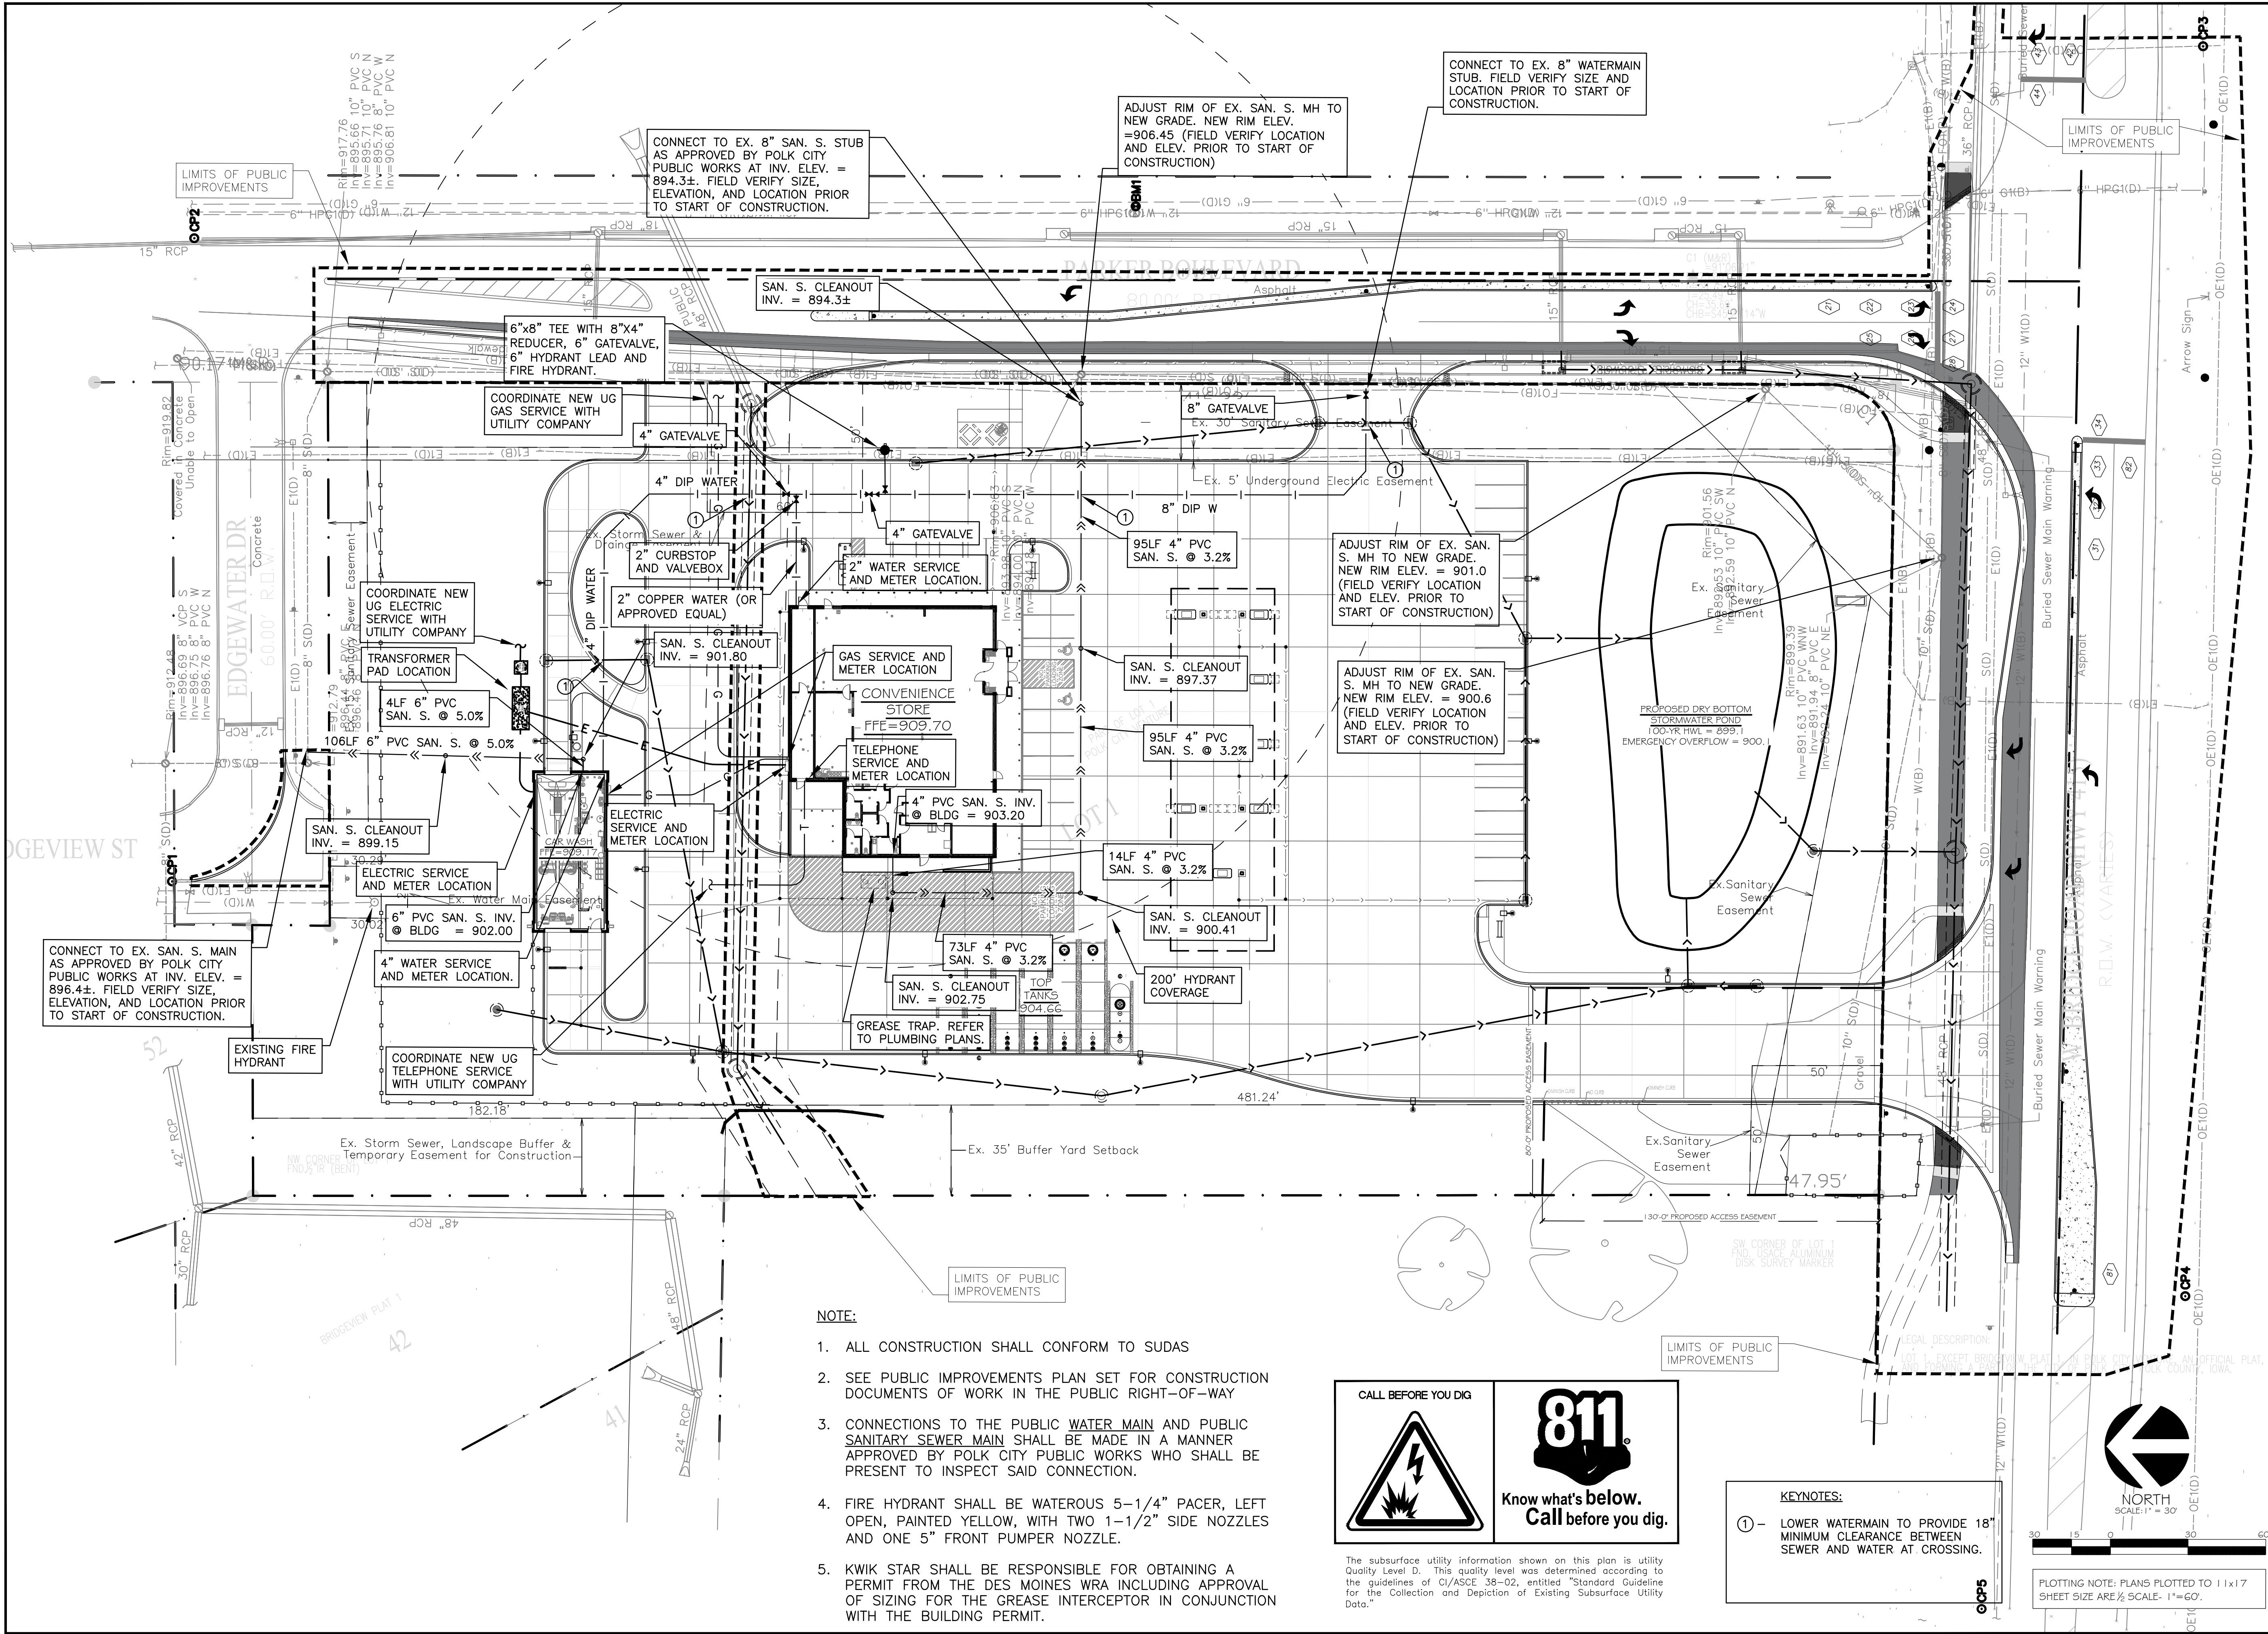

- NOTE:**
1. ALL CONSTRUCTION SHALL CONFORM TO SUDAS
 2. SEE PUBLIC IMPROVEMENTS PLAN SET FOR CONSTRUCTION DOCUMENTS OF WORK IN THE PUBLIC RIGHT-OF-WAY
 3. CONNECTIONS TO THE PUBLIC WATER MAIN AND PUBLIC SANITARY SEWER MAIN SHALL BE MADE IN A MANNER APPROVED BY POLK CITY PUBLIC WORKS WHO SHALL BE PRESENT TO INSPECT SAID CONNECTION.
 4. FIRE HYDRANT SHALL BE WATEROUS 5-1/4" PACER, LEFT OPEN, PAINTED YELLOW, WITH TWO 1-1/2" SIDE NOZZLES AND ONE 5" FRONT PUMPER NOZZLE.
 5. KWIK STAR SHALL BE RESPONSIBLE FOR OBTAINING A PERMIT FROM THE DES MOINES WRA INCLUDING APPROVAL OF SIZING FOR THE GREASE INTERCEPTOR IN CONJUNCTION WITH THE BUILDING PERMIT.



The subsurface utility information shown on this plan is utility Quality Level D. This quality level was determined according to the guidelines of CI/ASCE 38-02, entitled "Standard Guidelines for the Collection and Depiction of Existing Subsurface Utility Data."

KEYNOTES:
 ① - LOWER WATERMAIN TO PROVIDE 18" MINIMUM CLEARANCE BETWEEN SEWER AND WATER AT CROSSING.

NORTH
 SCALE: 1" = 30'



30 15 0 15 30 45 60

PLOTTING NOTE: PLANS PLOTTED TO 11x17 SHEET SIZE ARE 1/2" SCALE. 1"=60'.

Kwik Trip

Kwik Star

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 FAX (608) 781-8960

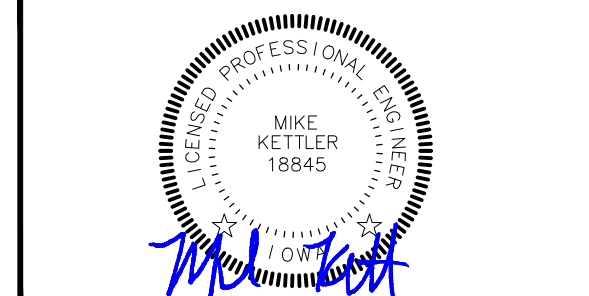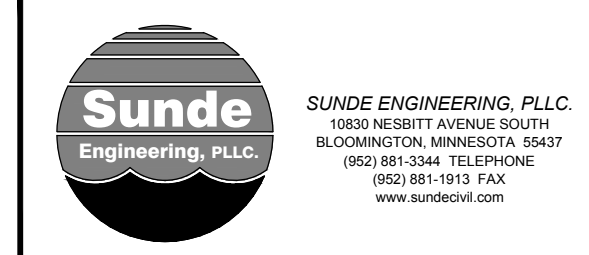

UTILITY PLAN

CONVENIENCE STORE 1089

POLK CITY, IOWA

NO.	DATE	DESCRIPTION
19AUG19	19AUG19	SUBMITTAL
23SEP19	23SEP19	COMMENTS
22NOV19	22NOV19	SITE SHIRT APPROACHES
06JAN20	06JAN20	SUBMITTAL
23JAN20	23JAN20	CANOPY LAYOUT
25FEB20	25FEB20	COMMENTS
18MAR20	18MAR20	SIGN LOCATION
03JUN20	03JUN20	COMMENTS
10JUN20	10JUN20	COMMENTS


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PROJ. NO. 191089


DATE 26JULY2019

SHEET **SP4**


INSITES 19-018 PW 5/2

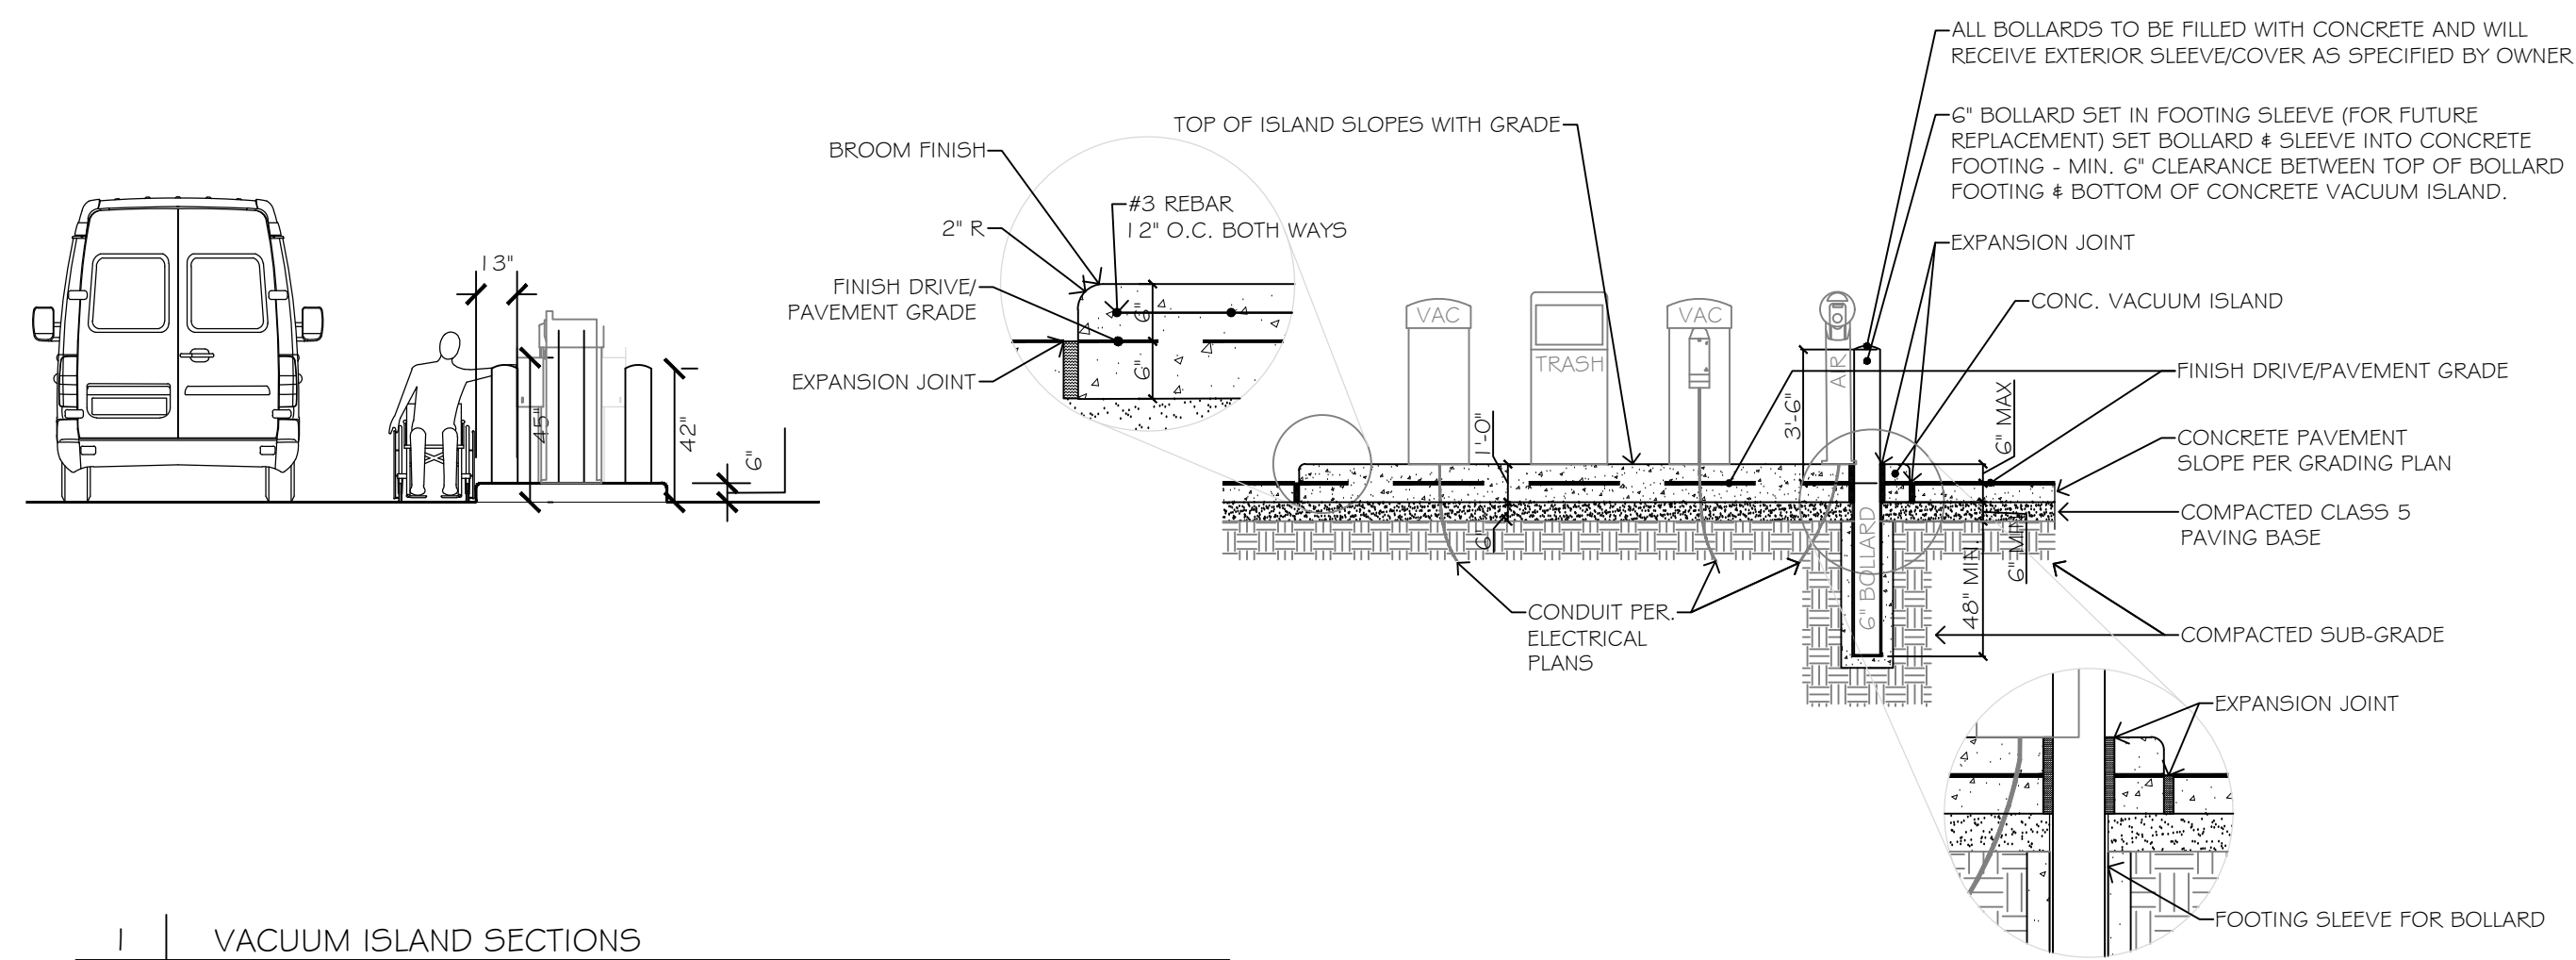


1 VACUUM ISLAND SECTIONS
SP5 NOT TO SCALE

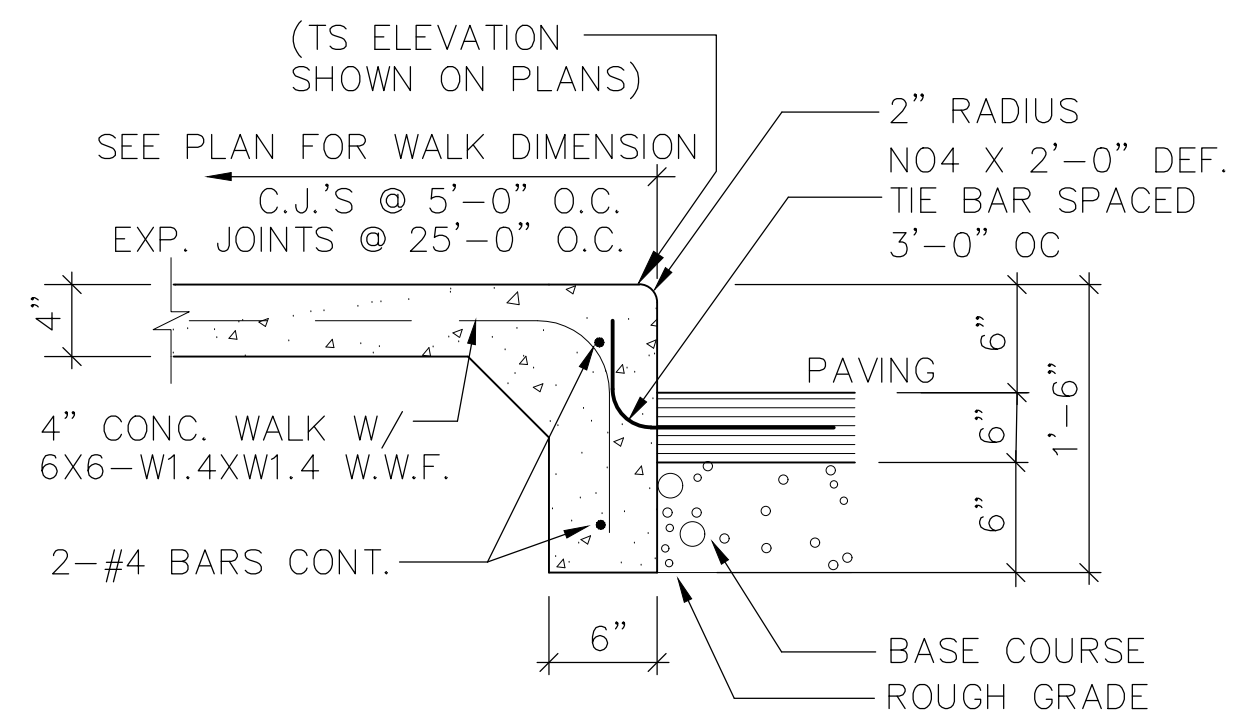


7 SIDEWALK/CURB DETAIL
SP5 NOT TO SCALE

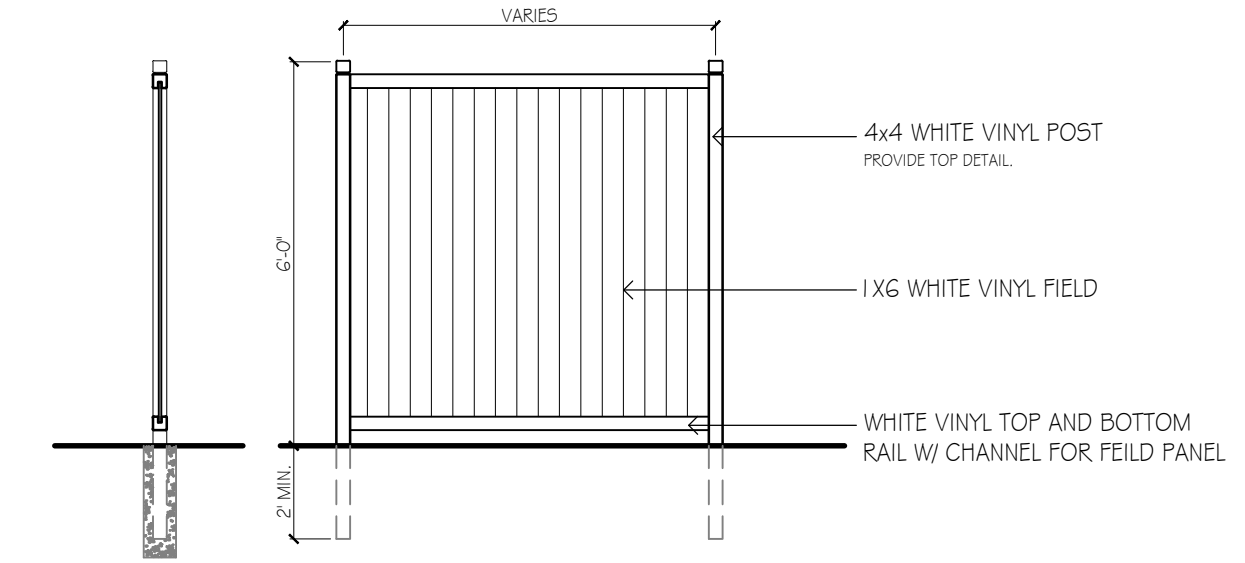


10 6' HT. SOLID VINYL PANEL SCREEN FENCE
SP5 SCALE - 1/4" = 1'-0"

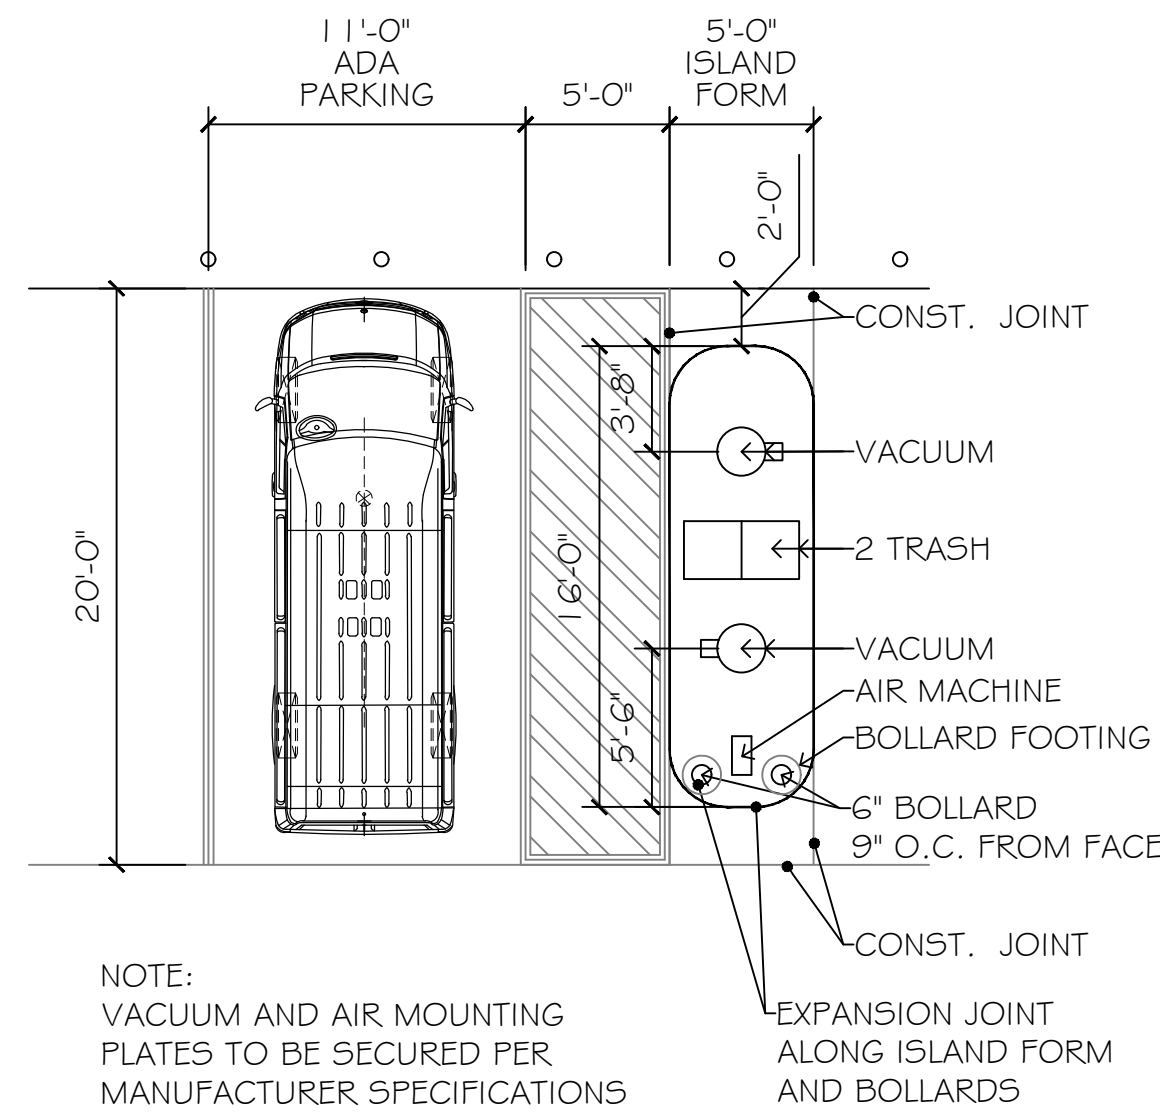


2 VACUUM ISLAND PLAN
SP5 NOT TO SCALE

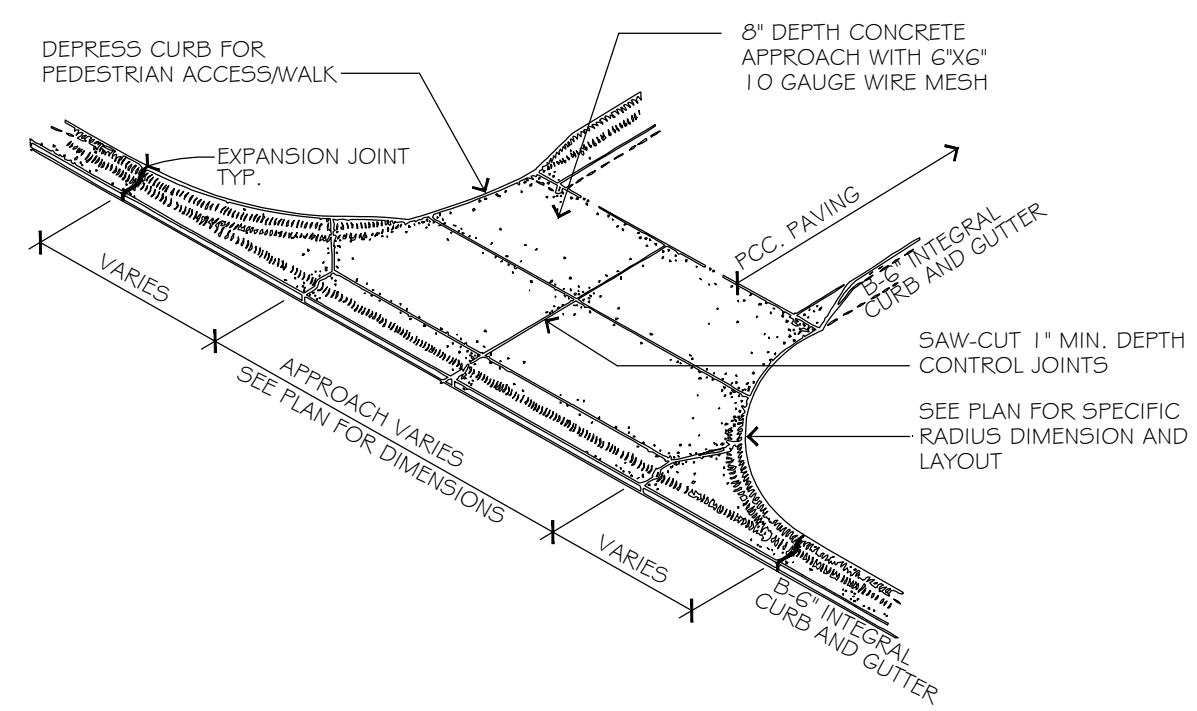


5 CONCRETE APPROACH DETAIL
SP5 NOT TO SCALE

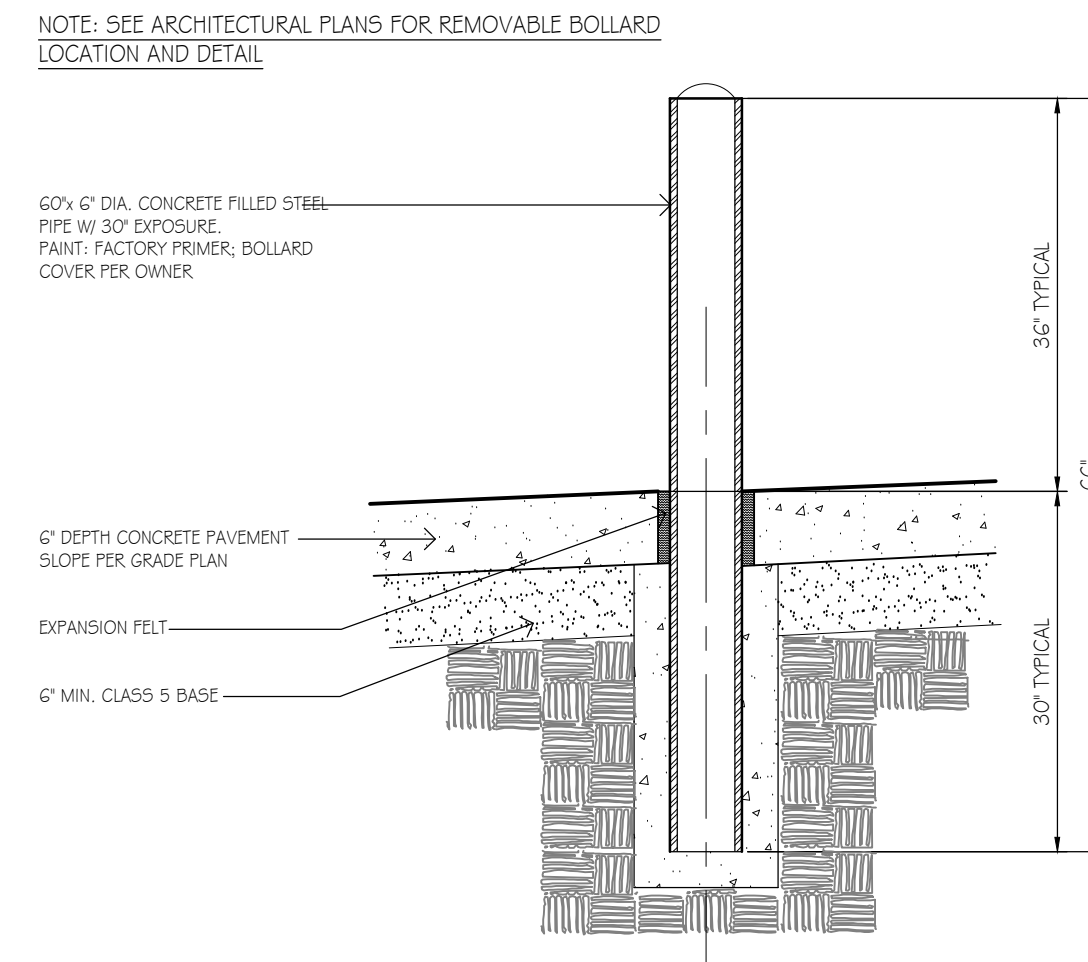


8 66" x 6" DIAMETER PIPE BOLLARD
SP5 SCALE - 3/8" = 1'-0"

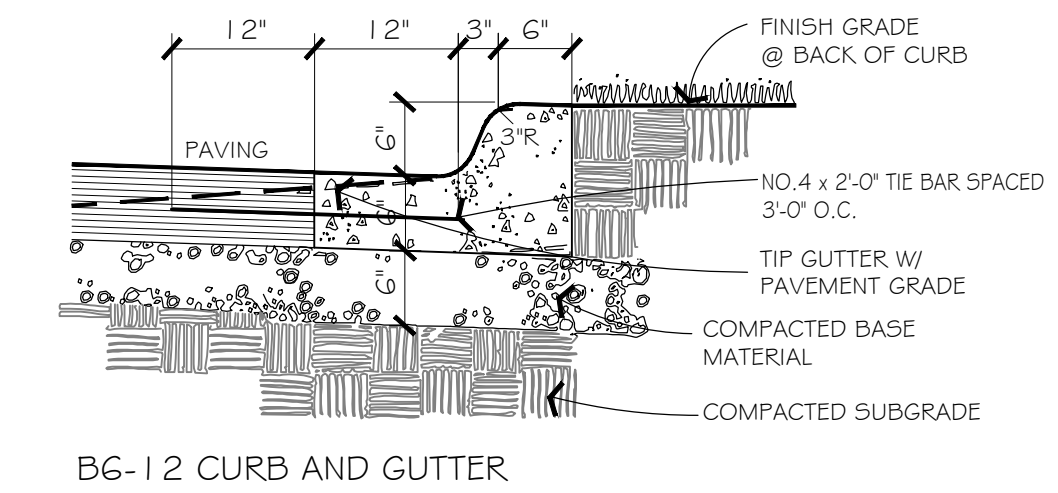


11 CONCRETE CURB DETAIL
SP5 SCALE - 3/4" = 1'-0"

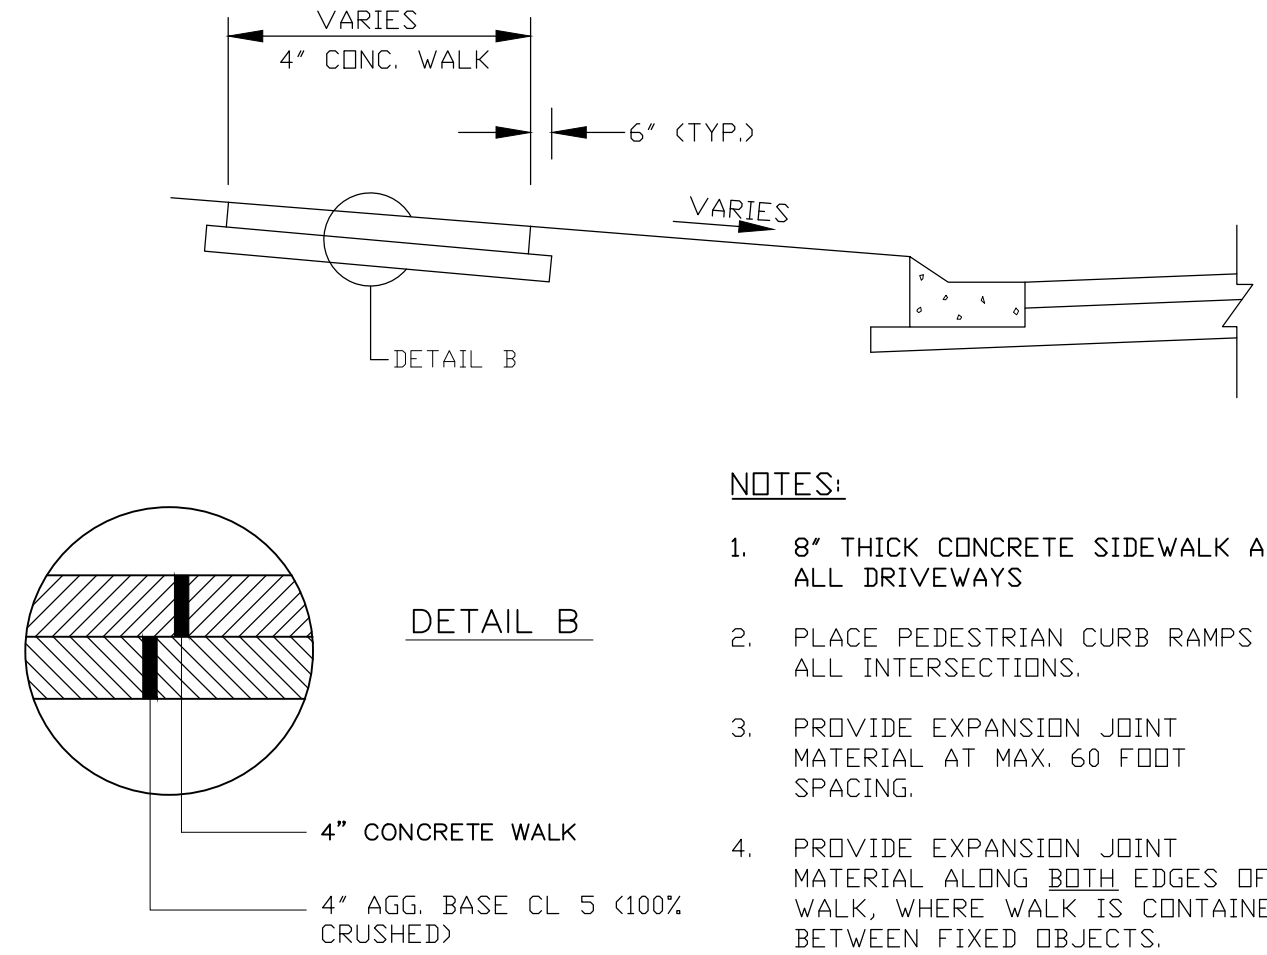


3 CONCRETE WALK/PAD DETAIL
SP5 NOT TO SCALE

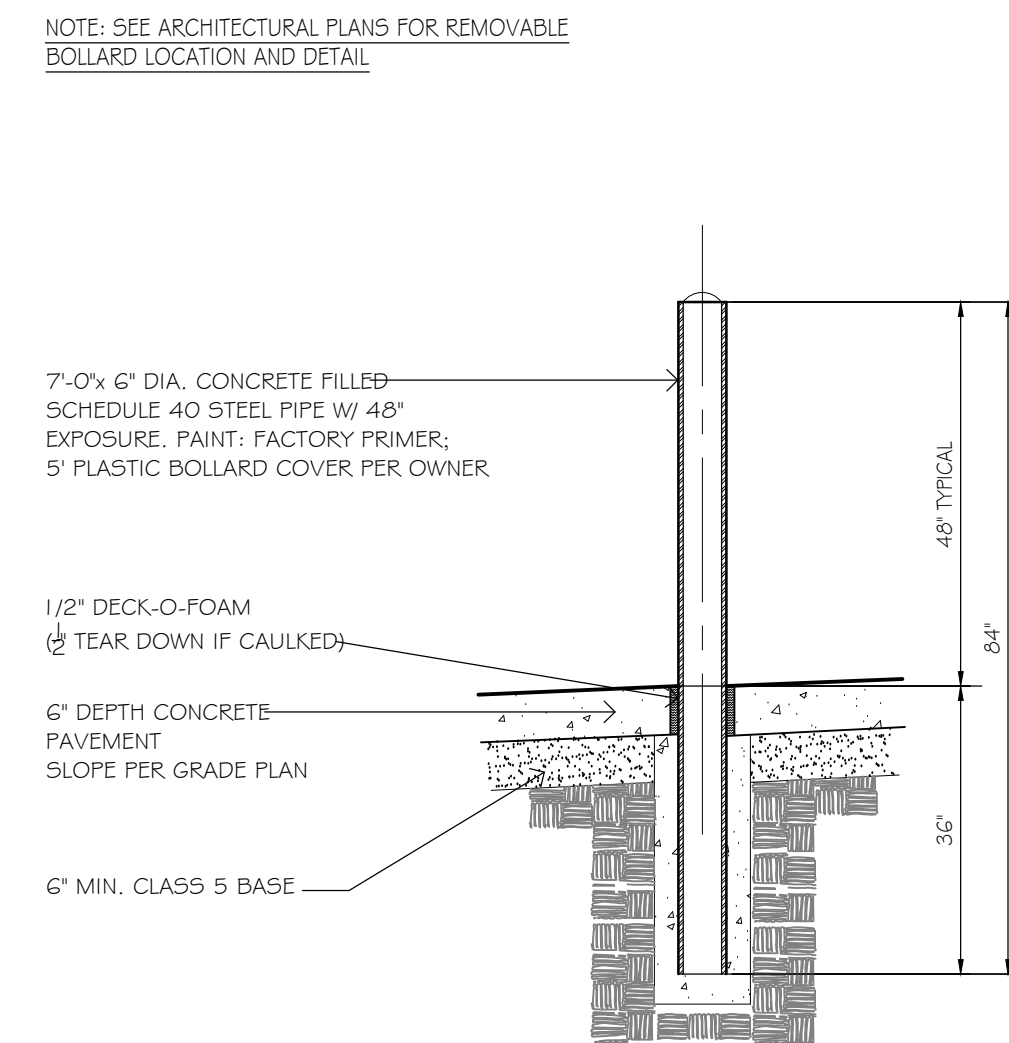

6 84" x 6" DIAMETER PIPE BOLLARD
SP5 SCALE - 1/2" = 1'-0"

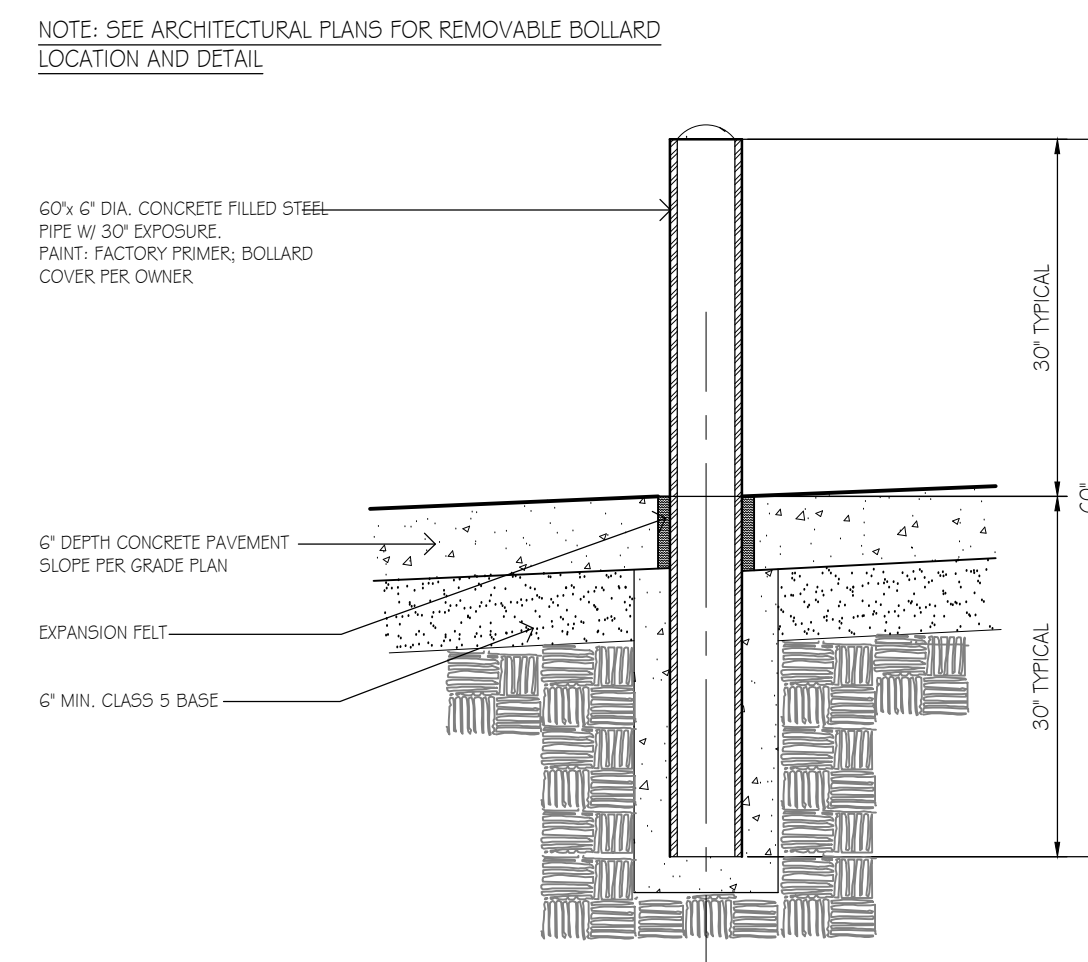

9 60" x 6" DIAMETER PIPE BOLLARD
SP5 SCALE - 3/8" = 1'-0"

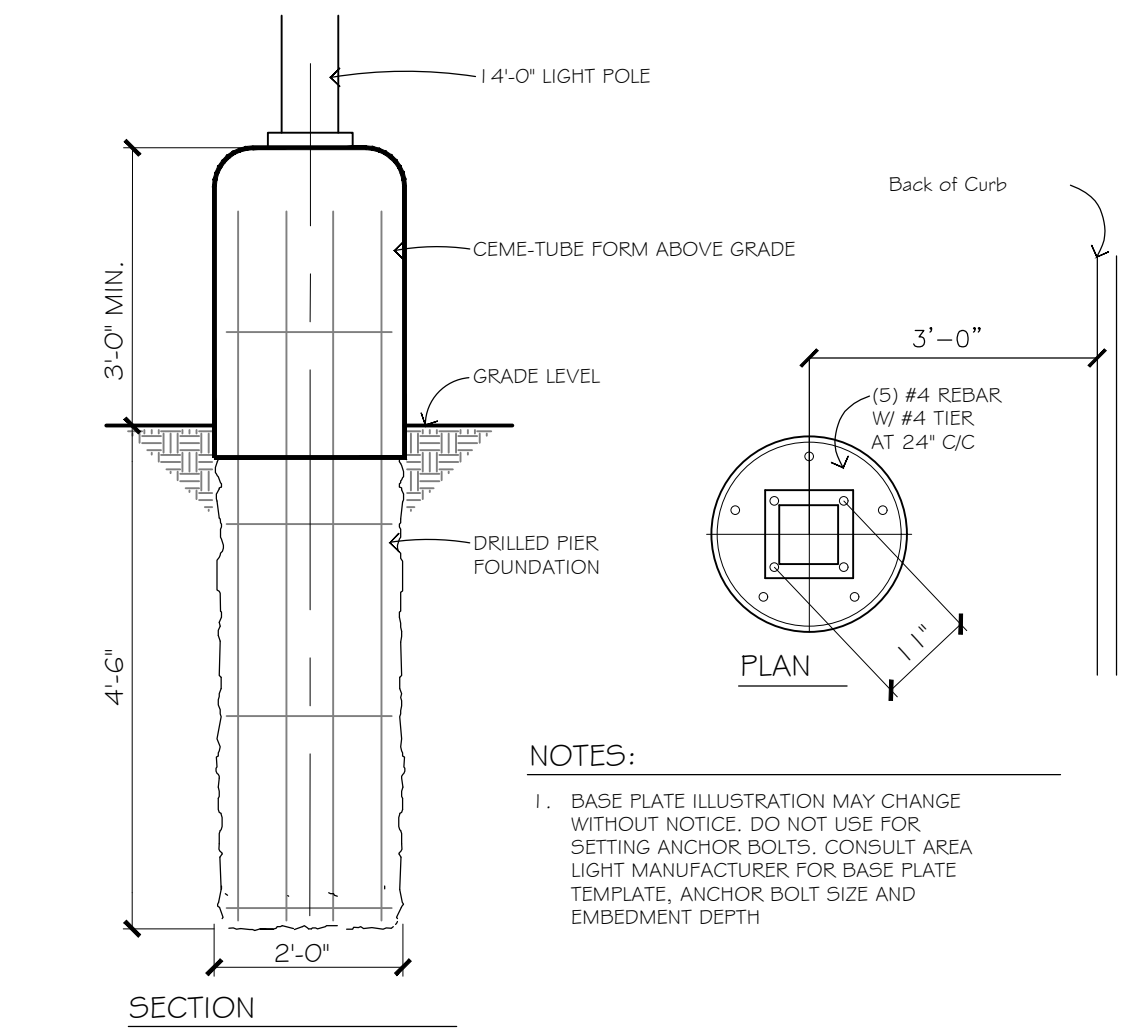


12 ROUND AREALIGHT FOUNDATION
SP5 SCALE - 1/2" = 1'-0"

Kwik Trip

Kwik Star

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INSITES
SITE PLANNING LANDSCAPE ARCHITECTURE
3131 Fernbrook Lane North, STE 260
Plymouth Minnesota 55447
763.383.8400
fax 763.383.8400

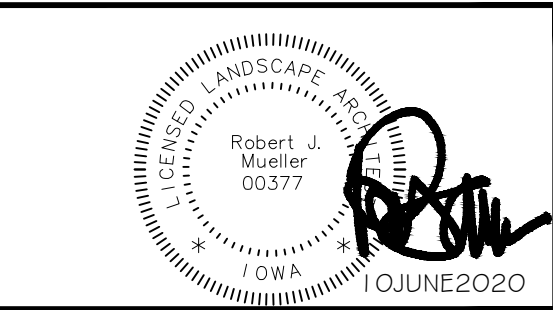

SITE PLAN DETAILS
CONVENIENCE STORE 1089
POLK CITY, IOWA

NO.	DATE	DESCRIPTION
1	19AUG19	SUBMITTAL
2	23SEP19	COMMENTS
3	22NOV19	SITE SHIFT APPROACHES
4	02JAN20	SUBMITTAL
5	23JAN20	CANOPY LAYOUT
6	25FEB20	COMMENTS
7	11MAR20	SIGN LOCATION
8	03JUN20	COMMENTS
9	10JUN20	COMMENTS

DRAWN BY _____
SCALE _____ GRAPHIC
PROJ. NO. 191089
DATE 26JULY2019
SHEET **SP5**

1
SPG

5
SPG

8
SPG

2
SPG

3
SPG

6
SPG


9
SPG

Kwik Trip

Kwik Star

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 LACROSSE, WI 54602-2107
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INSITES
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 Plymouth Minnesota 55447
 763.383.8400
 Fax 763.383.8400

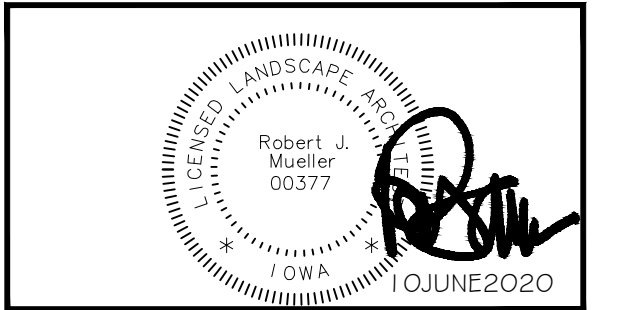

SITE PLAN DETAILS

CONVENIENCE STORE 1089


POLK CITY, IOWA

NO.	DATE	DESCRIPTION
1	19AUG19	SUBMITTAL COMMENTS
2	23SEP19	COMMENTS
3	22NOV19	SITE SHIFT APPROACHES
4	06JAN20	SUBMITTAL COMMENTS
5	23JAN20	CANOPY LAYOUT
6	25FEB20	COMMENTS
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8	03JUN20	COMMENTS
9	10JUN20	COMMENTS


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 SCALE: _____ GRAPHIC
 PROJ. NO.: 191089
 DATE: 26JULY2019
 SHEET: _____

SP6


INSITES 19.01.18 REV 5.2

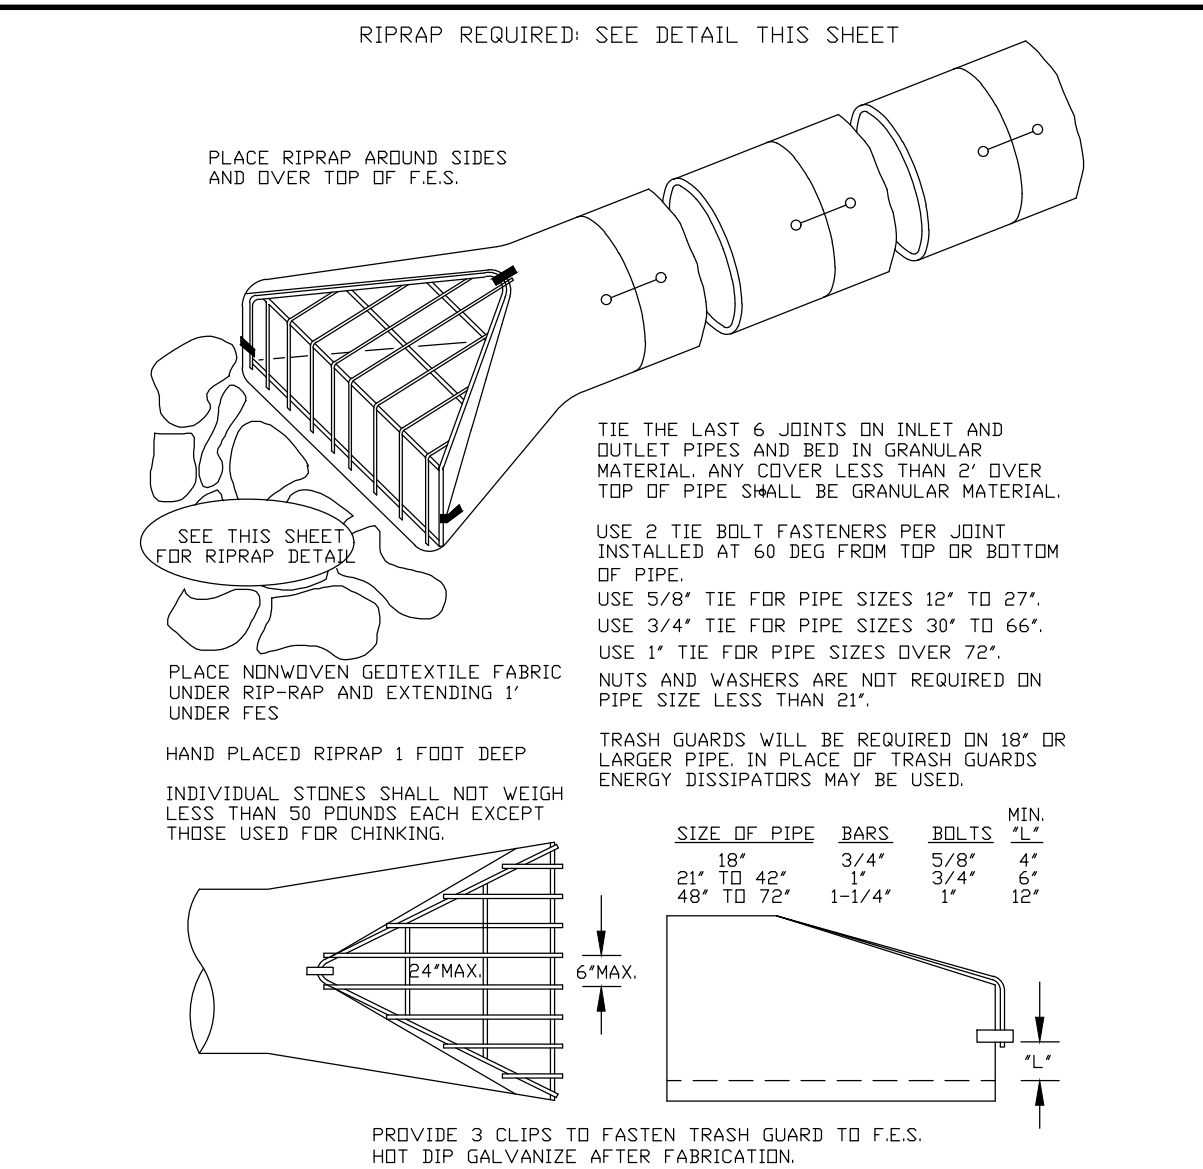


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SPG

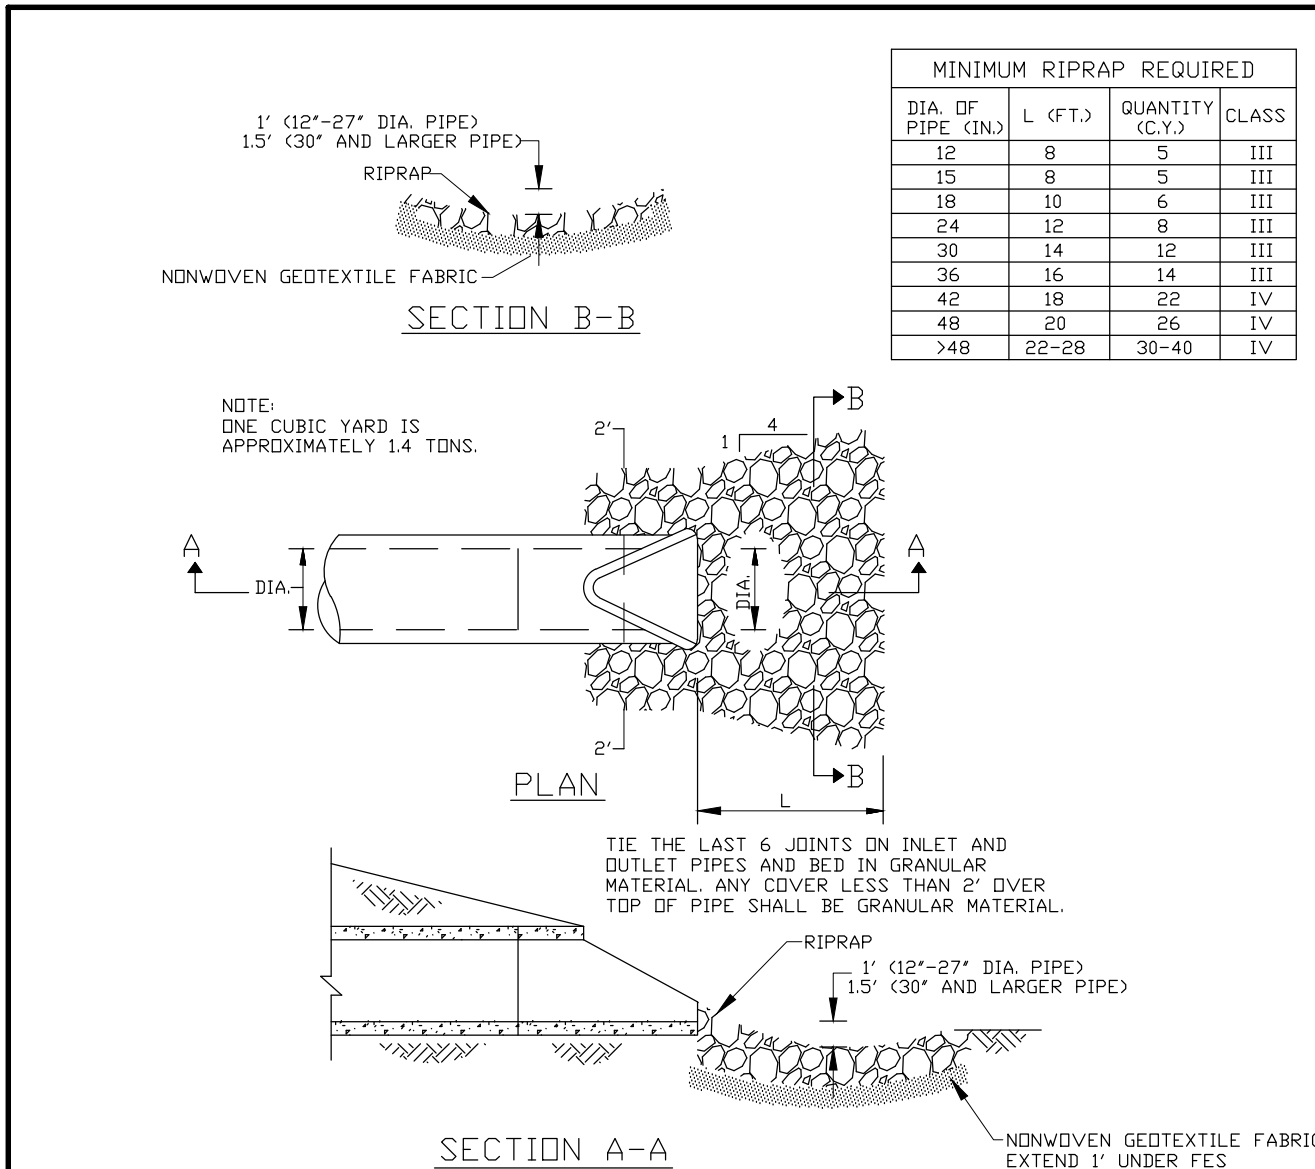


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SPG

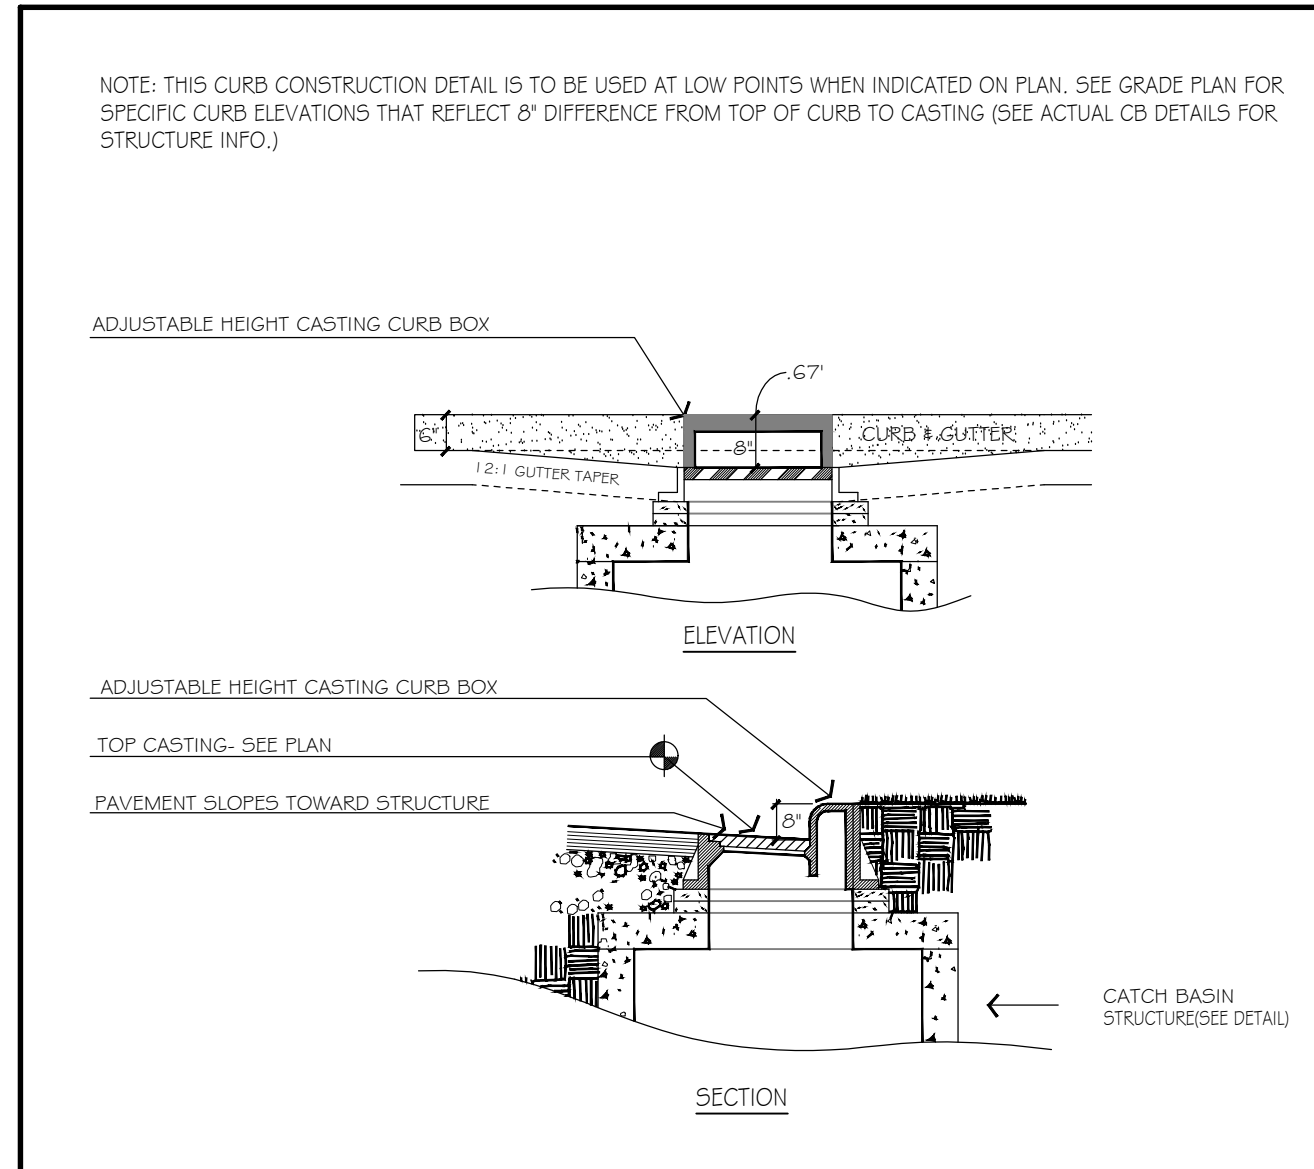


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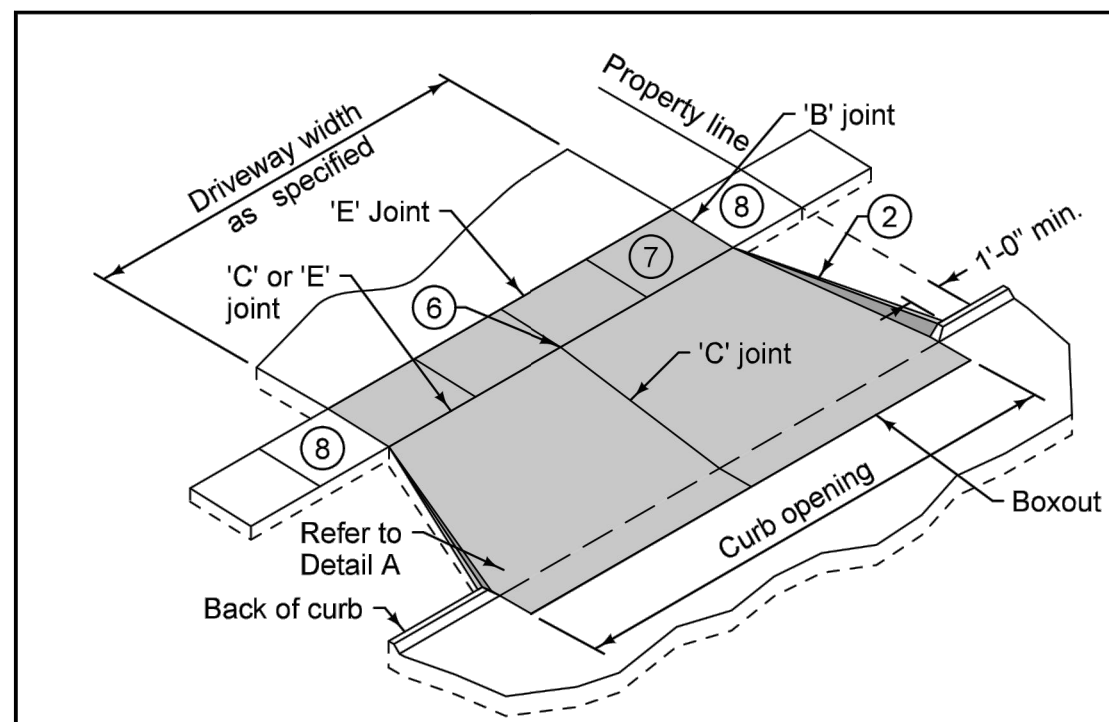
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SPG

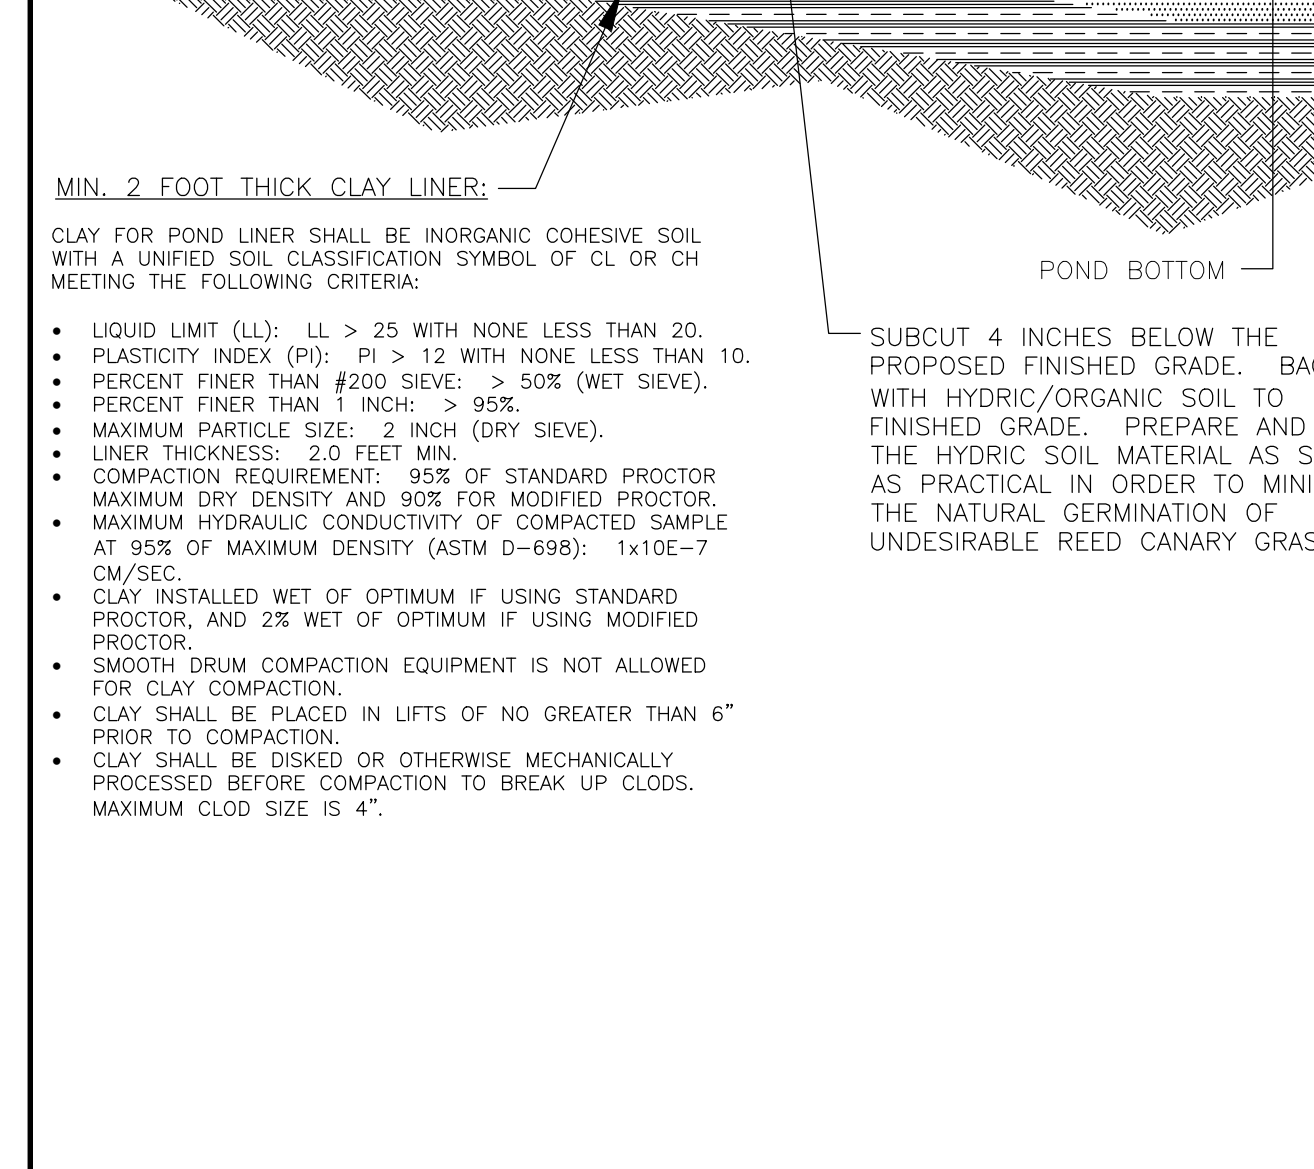


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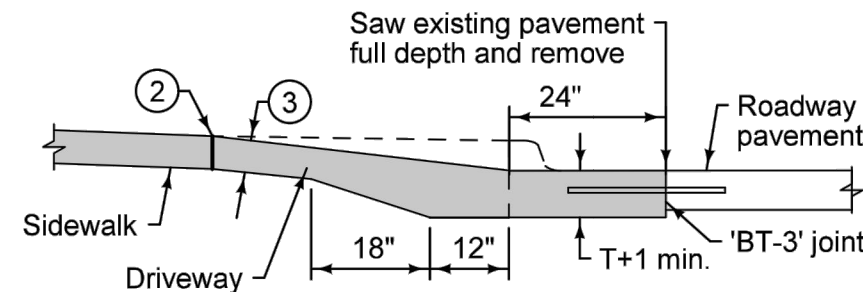
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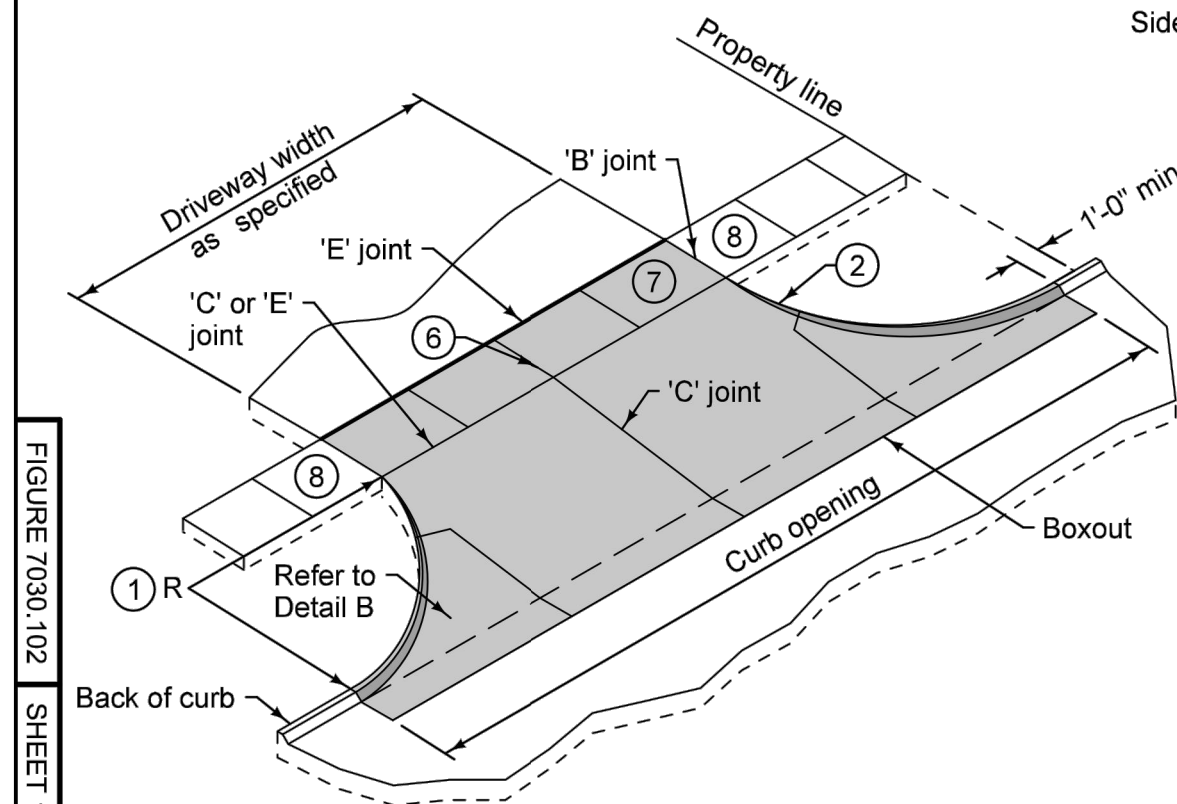
TYPE B WITH FLARES

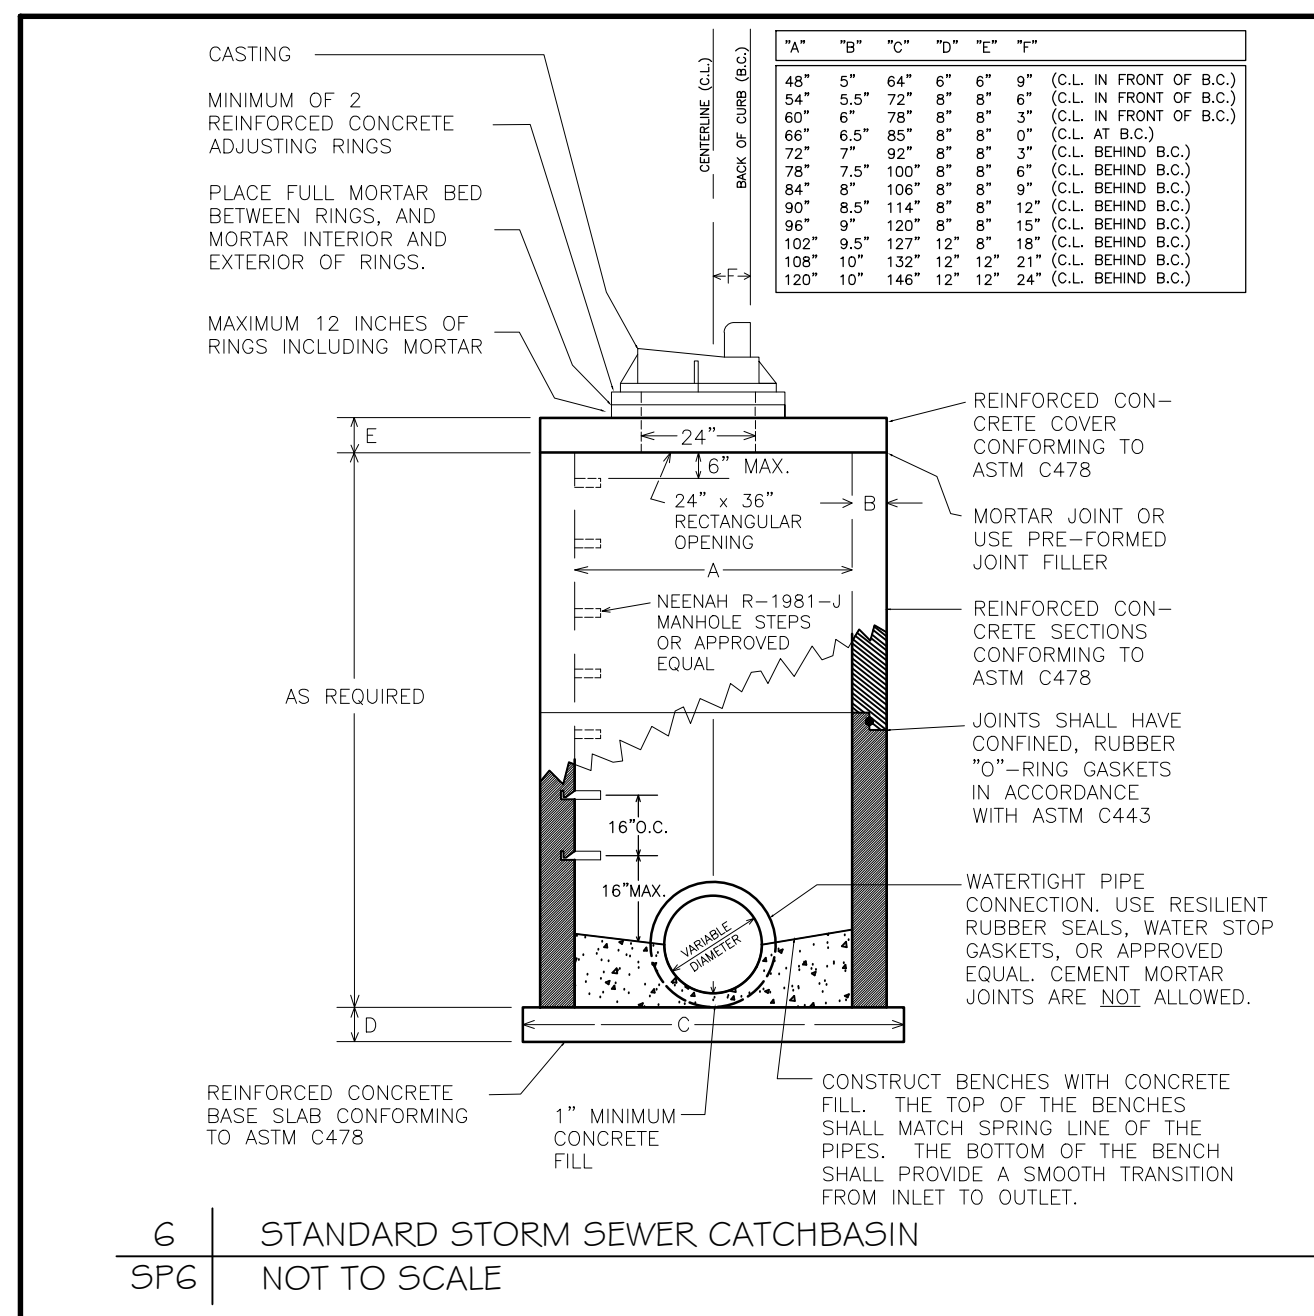


DETAIL A

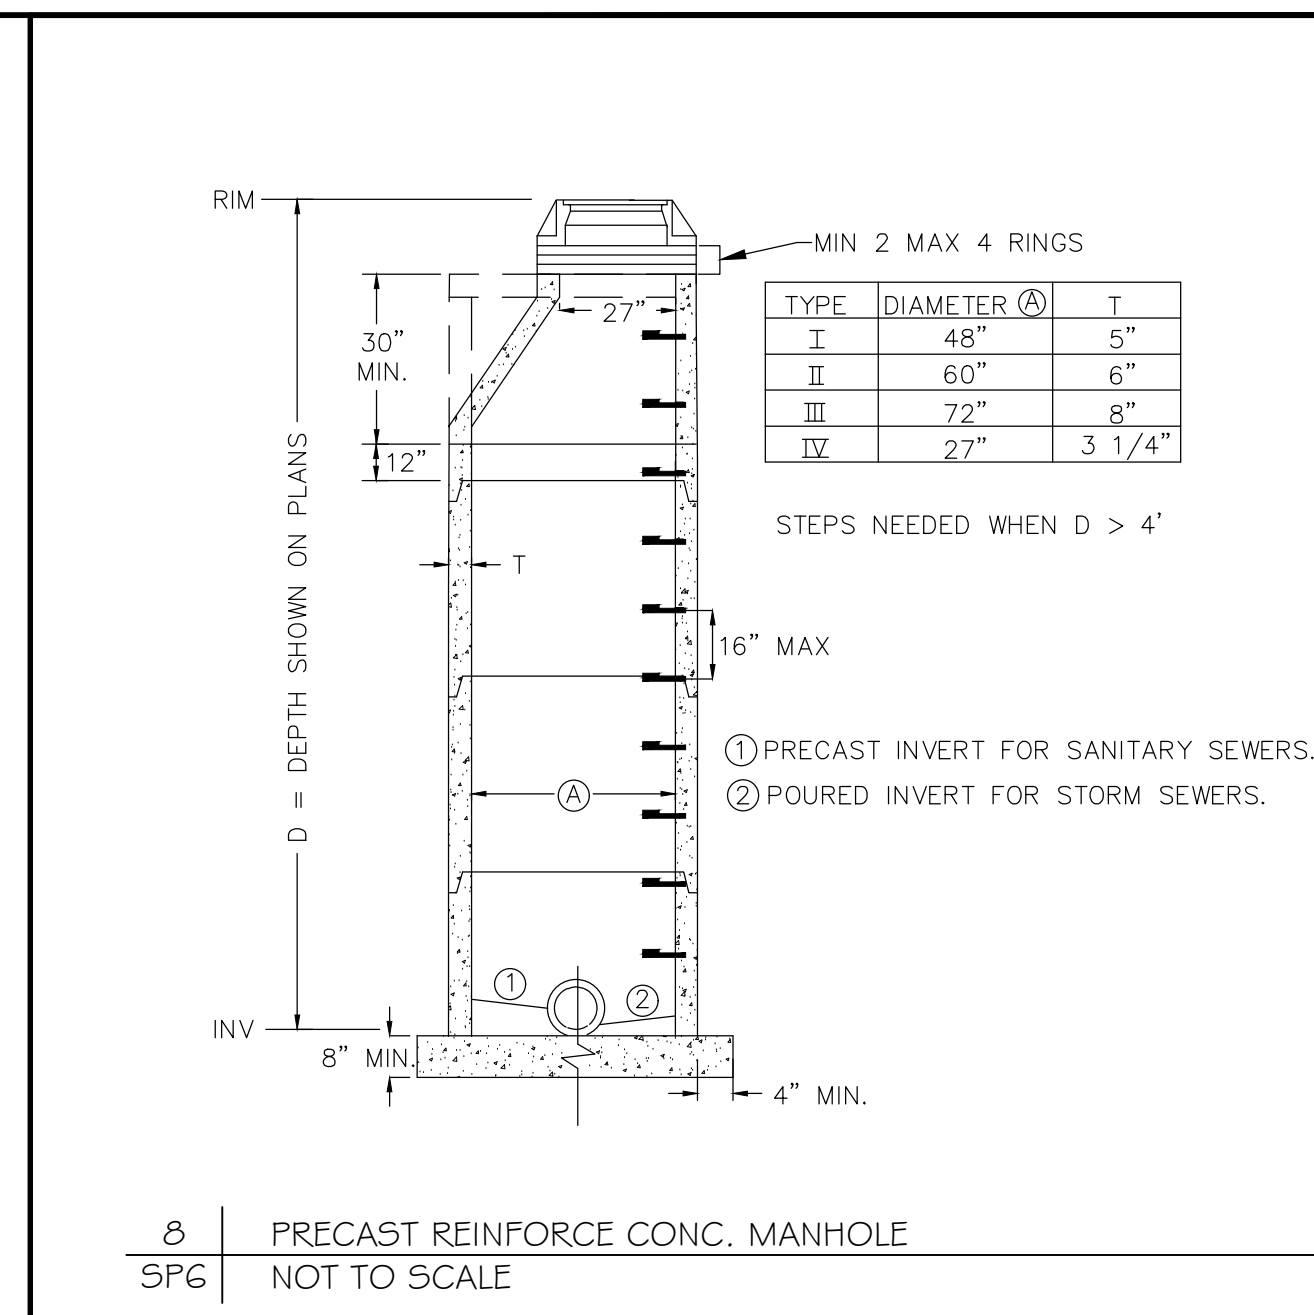

SECTION A-A

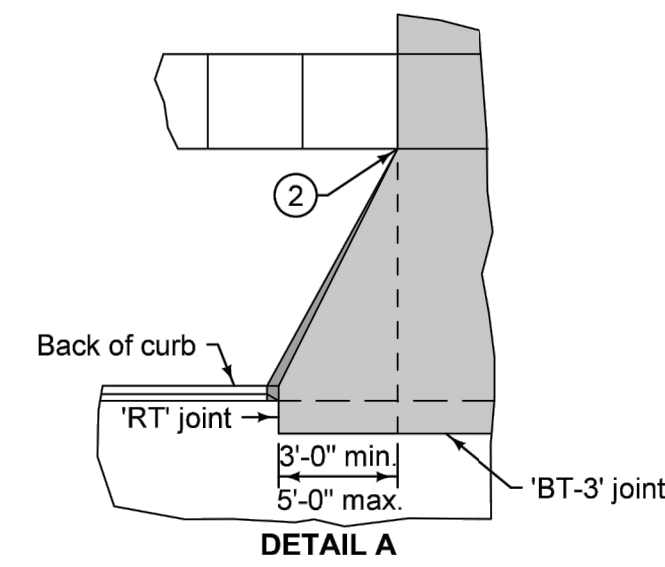

TYPE B WITH RADII

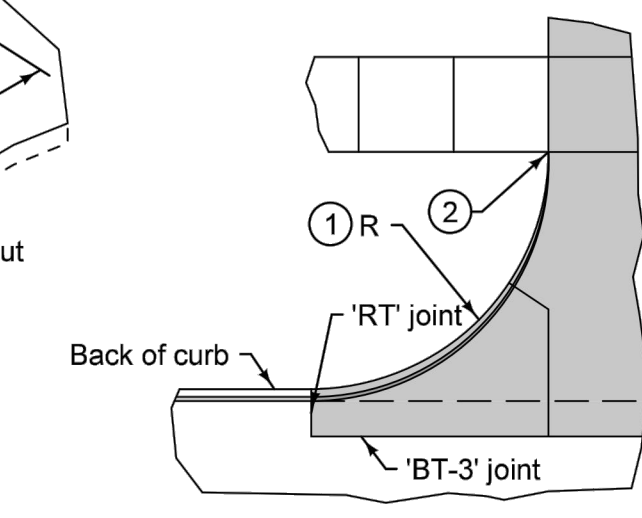

DETAIL B


- 1 Driveway radius (R). Residential: 10 foot minimum, 15 foot maximum. Commercial and industrial: As specified in the contract documents.
- 2 Transition the curb height to 0 inches at end of taper/radius or at the front edge of sidewalk. Do not extend raised curb cross sidewalk.
- 3 Pavement thickness. Residential: 6 inches minimum. Commercial and industrial: 7 inches minimum.
- 4 Sidewalk thickness through driveway to match thickness of driveway.
- 5 If longitudinal joint is located 48 inches or less from the back of curb, extend boxout to joint line. Full depth saw cut is still required.
- 6 For alleys, invert the pavement crown 2% toward the center of the alley.
- 7 Target cross slope of 1.5% with a maximum cross slope of 2.0%. If specified in the contract documents, construct the sidewalk through the driveway 5 feet wide to serve as a passing space.
- 8 If cross slope of adjacent sidewalk panel exceeds 2.0%, remove and replace to transition from existing sidewalk to sidewalk through driveway. If the elevation change requires a curb ramp, comply with Figures 7030.205; verify need for detectable warning panel with Engineer.

SUDAS	REVISION	10-20-15
	2	10-20-15
7030.102		SHEET 1 of 1

SUDAS Standard Specifications


CONCRETE DRIVEWAY, TYPE B

FIGURE 7030.205 SHEET 1 OF 1

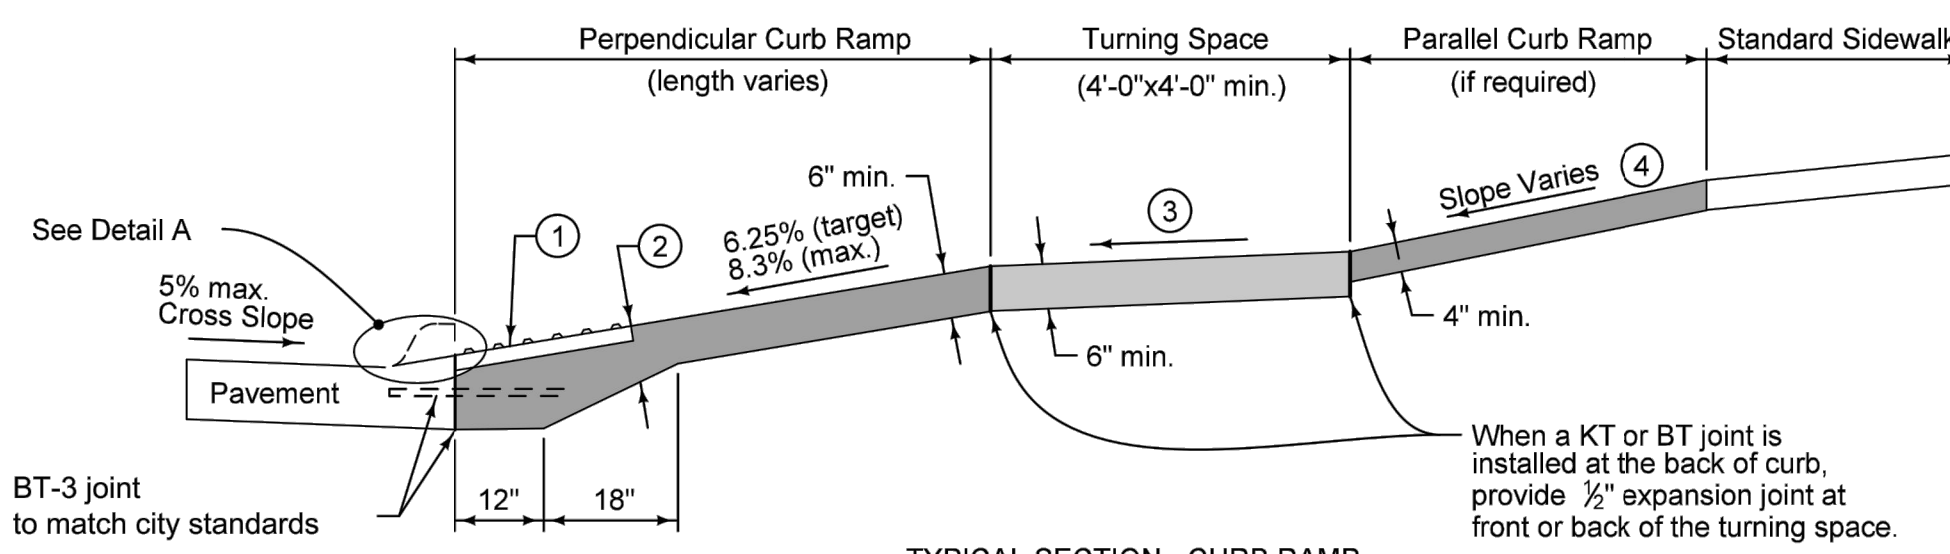


TYPICAL SECTION - CURB RAMP

- Key
- BT-3 joint to match city standards
 - Curb Ramp
 - Turning Space
 - Detectable warning

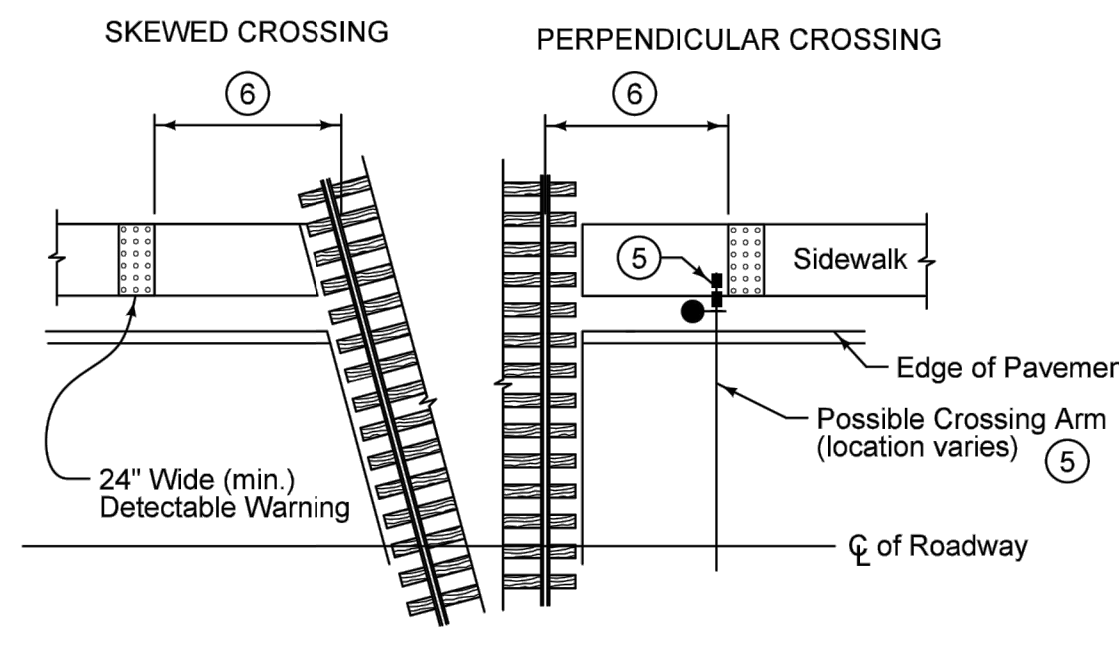

DETECTABLE WARNING LOCATION AT RAILROAD CROSSING

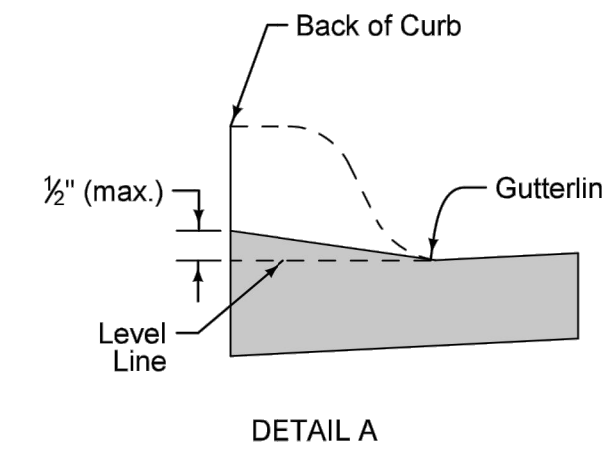

DETAIL A

- 1 Provide a minimum 2 foot width of detectable warning surfaces in the direction of pedestrian travel across the full width of the curb ramp or turning space, exclusive of curbs or flares.
- 2 Provide a minimum of 6 inches of concrete below the detectable warning panel.
- 3 Minimum 4 feet by 4 feet. Target cross slope of 1.5% with a maximum cross slope of 2.0%.
- 4 If normal sidewalk elevation cannot be achieved with the perpendicular ramp between the street and landing due to limited ramp length, provide a parallel ramp to make up the elevation difference between the landing and the standard sidewalk.


The length of the parallel ramp is not required to exceed 15 feet, regardless of the resulting slope. Do not exceed 8.3% slope for parallel ramps shorter than 15 feet.
- 5 If crossing gate conflicts with location of detectable warning or if pedestrian crossing gate is provided, place detectable warning panel in advance of the crossing gate.
- 6 Locate front edge of detectable warning panel 12 to 15 feet from centerline of nearest rail. Orient truncated domes parallel to the direction of pedestrian travel.

SUDAS	REVISION	10-20-15
	1	10-20-15
7030.205		SHEET 1 of 1


SUDAS Standard Specifications

GENERAL SIDEWALK AND CURB RAMP DETAILS


FIGURE 7030.205 SHEET 1 OF 1

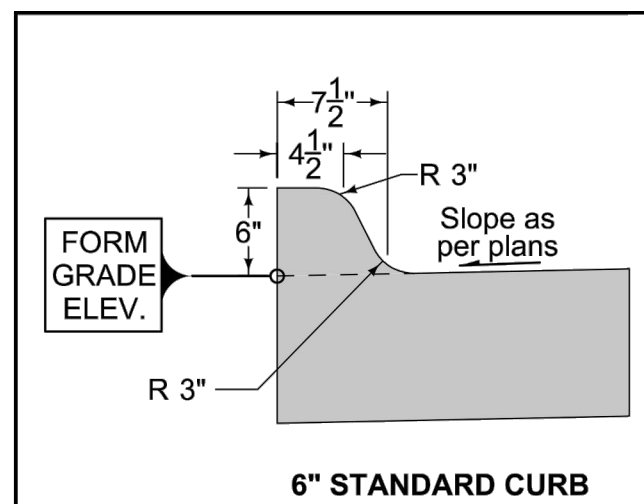


6" STANDARD CURB

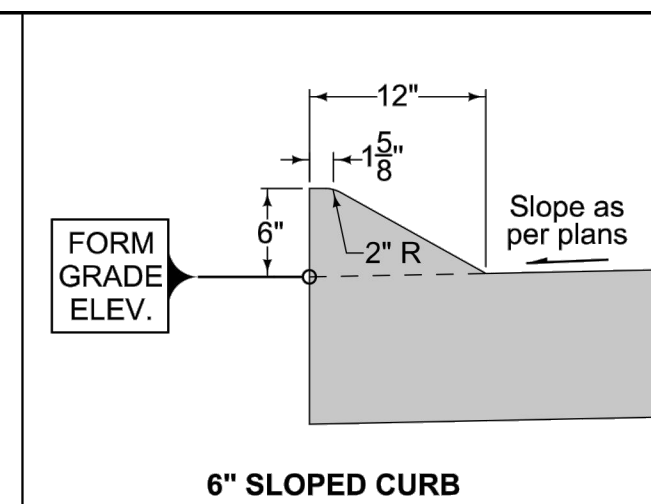


6" SLOPED CURB

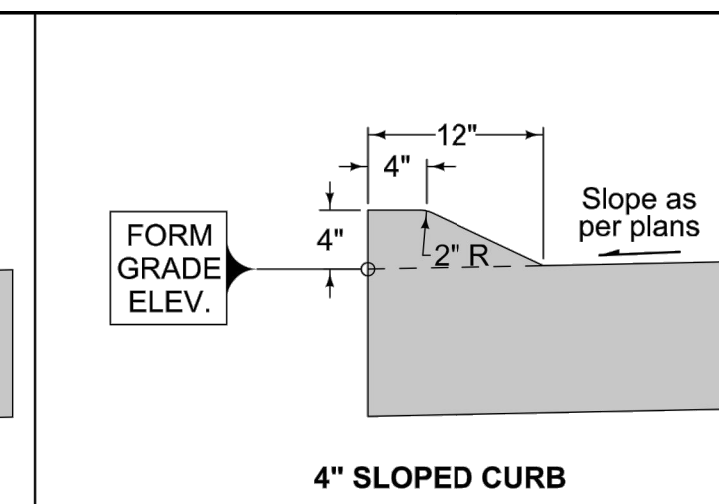


4" SLOPED CURB

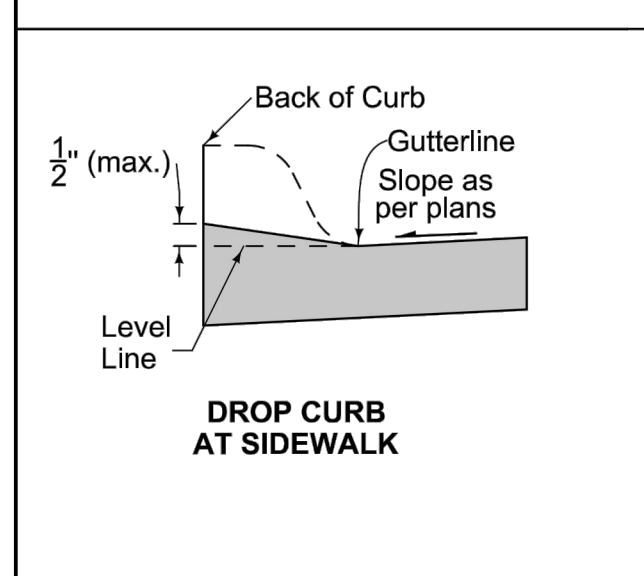

DROP CURB AT SIDEWALK

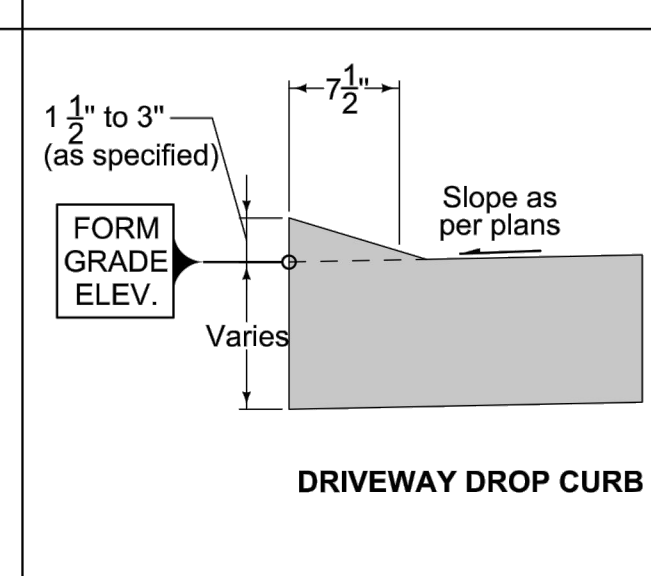

DRIVEWAY DROP CURB

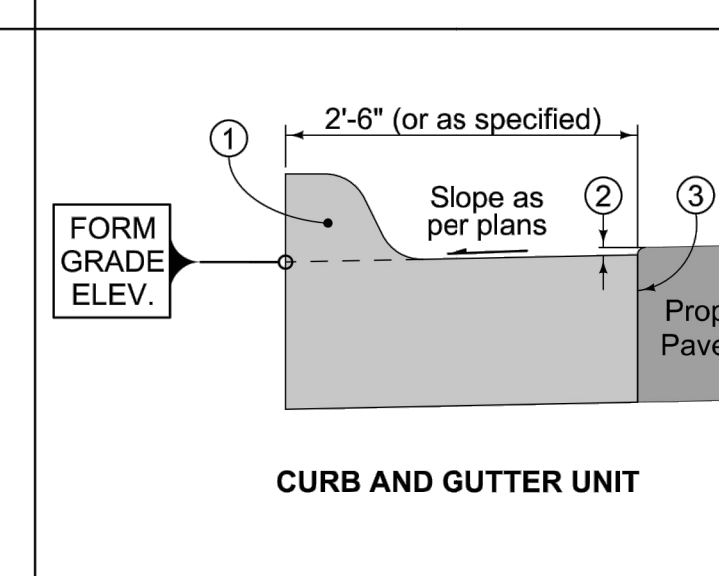

CURB AND GUTTER UNIT

For joint details, see PV-101.

- 1 6" Standard Curb, 6" Sloped Curb, or 4" Sloped Curb as specified.
- 2 1/4" if Proposed Pavement is HMA. No elevation difference if Proposed Pavement is PCC.
- 3 'BT', 'KT', or 'L' joint if Proposed Pavement is PCC. 'B' joint if Proposed Pavement is HMA.

SUDAS	REVISION	10-18-16
	4	10-18-16
PV-102		SHEET 1 of 2

FIGURE 7010.102 STANDARD ROAD PLAN


REVISIONS: Added note: Shows use of detail on Drop Curb views on page 1. Updated DOT logo to new version.

For joint details, see PV-101.


FIGURE 7010.102 SHEET 1 OF 2

CONCRETE PIPE APRON GUARD

FIGURE 7010.102 SHEET 1 OF 2

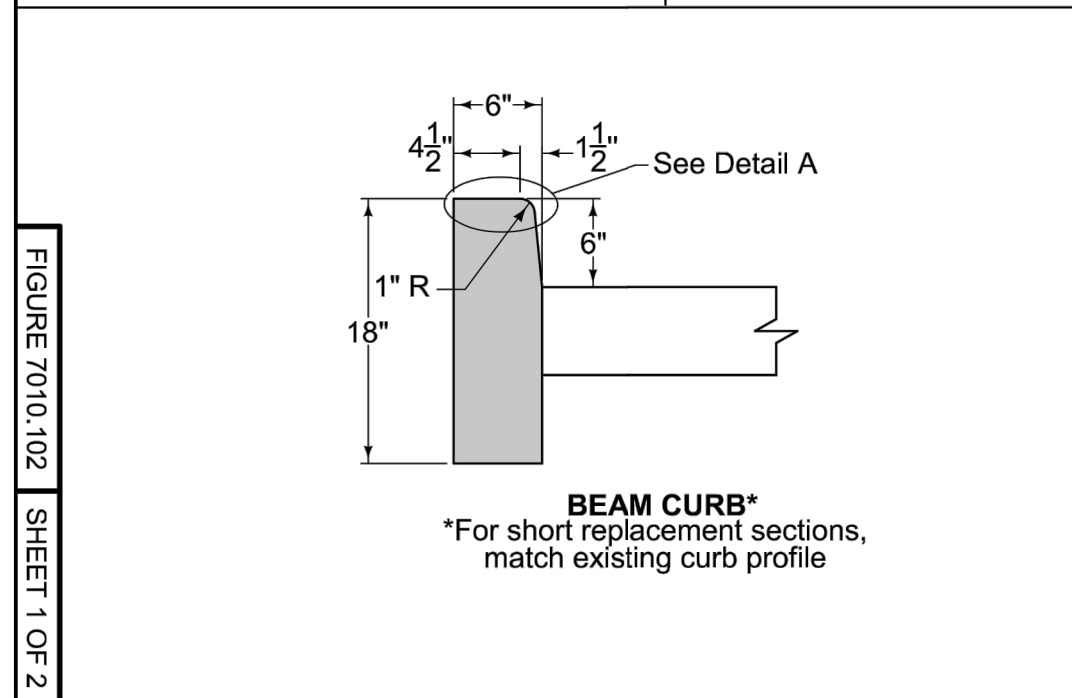

BEAM CURB*
*For short replacement sections, match existing curb profile

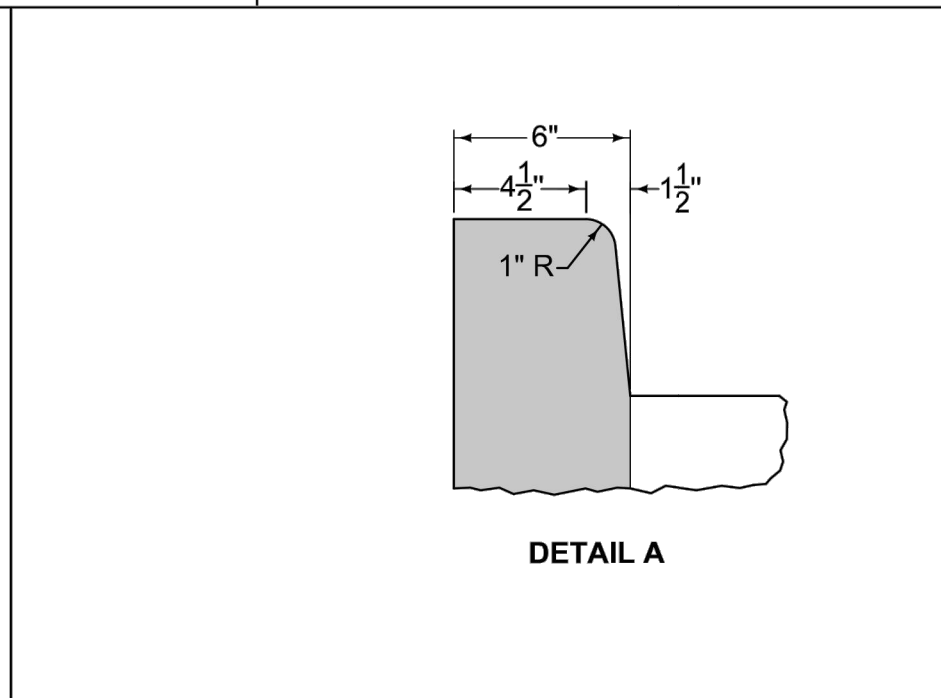

DETAIL A

SUDAS	REVISION	10-18-16
	4	10-18-16
PV-102		SHEET 1 of 2

FIGURE 7010.102 STANDARD ROAD PLAN

REVISIONS: Added note: Shows use of detail on Drop Curb views on page 1. Updated DOT logo to new version.

For joint details, see PV-101.

FIGURE 7010.102 SHEET 1 OF 2

CONCRETE PIPE APRON GUARD

FIGURE 7010.102 SHEET 1 OF 2

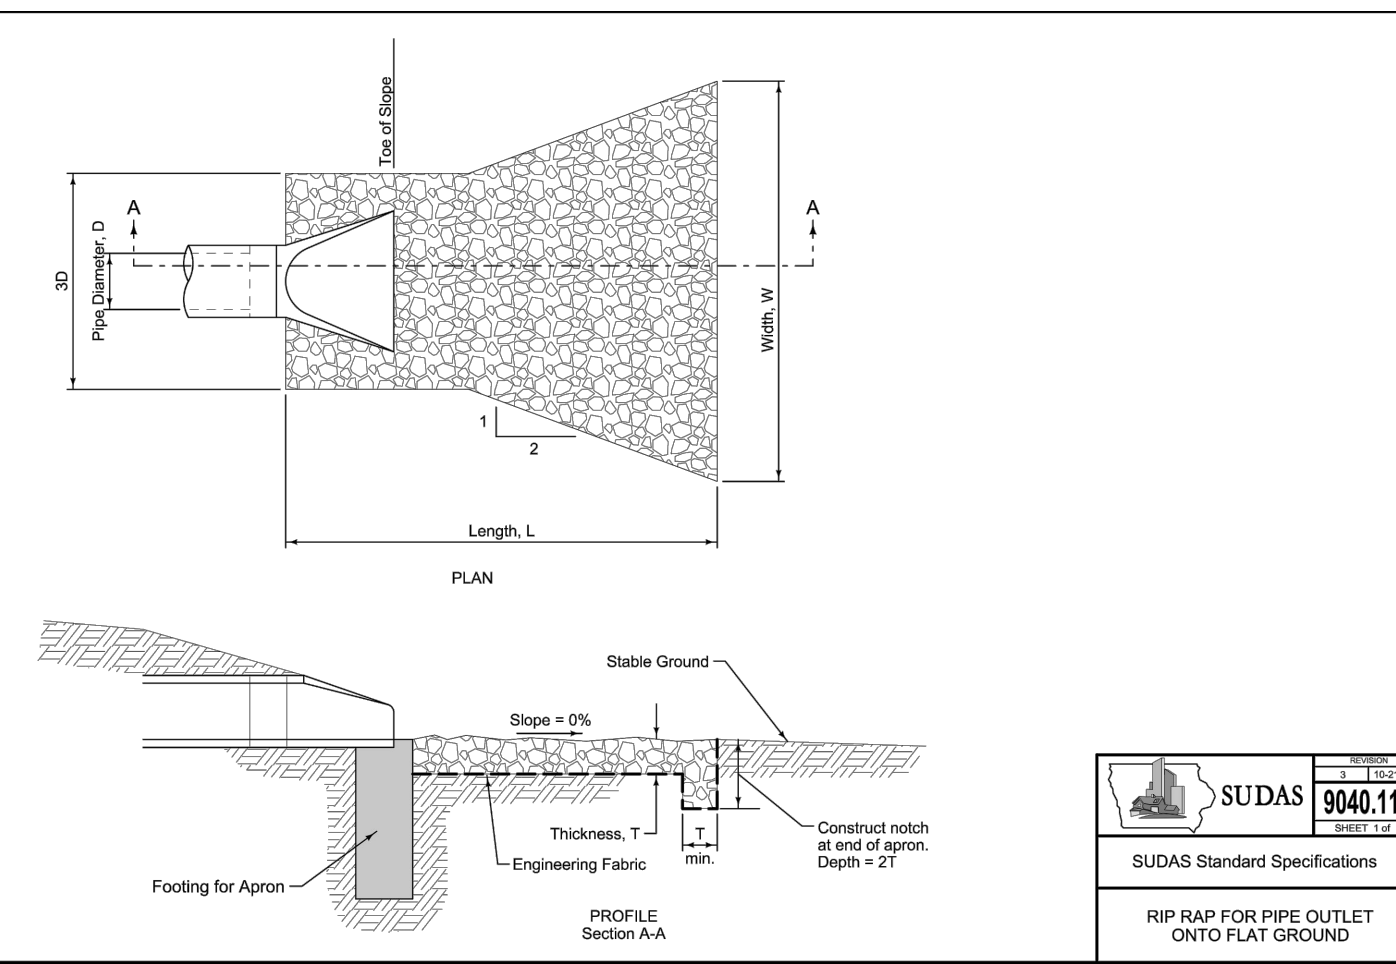


FIGURE 9040.110 SHEET 1 OF 1

SUDAS Standard Specifications

CONCRETE PIPE APRON GUARD

FIGURE 9040.110 SHEET 1 OF 1

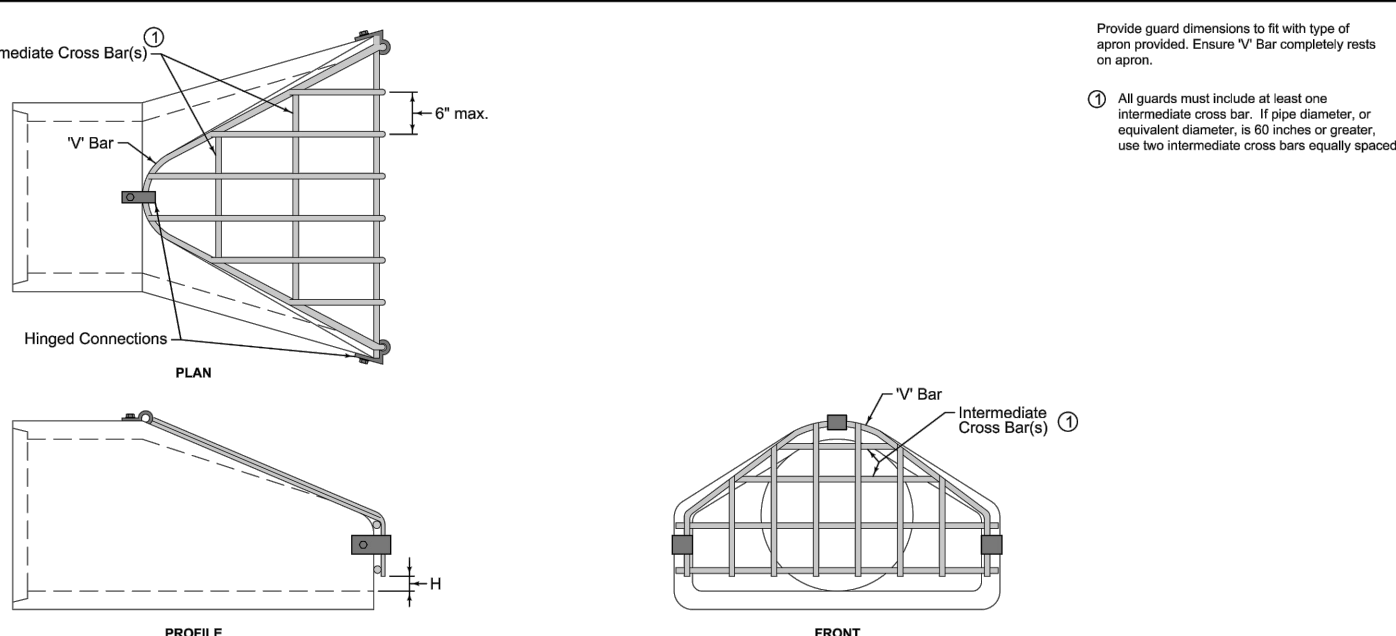


FIGURE 4030.224 SHEET 1 OF 1

SUDAS Standard Specifications

CONCRETE PIPE APRON GUARD

FIGURE 4030.224 SHEET 1 OF 1

PIPE SIZE (IN. Ø)	BAR SIZE (IN. Ø)	BAR SPACING (IN.)	BAR LENGTH (IN.)
12"	1/2"	12"	12"
18"	3/4"	12"	12"
24"	1"	12"	12"
30"	1 1/4"	12"	12"
36"	1 1/2"	12"	12"
42"	1 3/4"	12"	12"
48"	2"	12"	12"
54"	2 1/4"	12"	12"
60"	2 1/2"	12"	12"
66"	2 3/4"	12"	12"
72"	3"	12"	12"
78"	3 1/4"	12"	12"
84"	3 1/2"	12"	12"
90"	3 3/4"	12"	12"
96"	4"	12"	12"
102"	4 1/4"	12"	12"
108"	4 1/2"	12"	12"
114"	4 3/4"	12"	12"
120"	5"	12"	12"
126"	5 1/4"	12"	12"
132"	5 1/2"	12"	12"
138"	5 3/4"	12"	12"
144"	6"	12"	12"

FIGURE 4030.224 SHEET 1 OF 1

SUDAS Standard Specifications

CONCRETE PIPE APRON GUARD

FIGURE 4030.224 SHEET 1 OF 1

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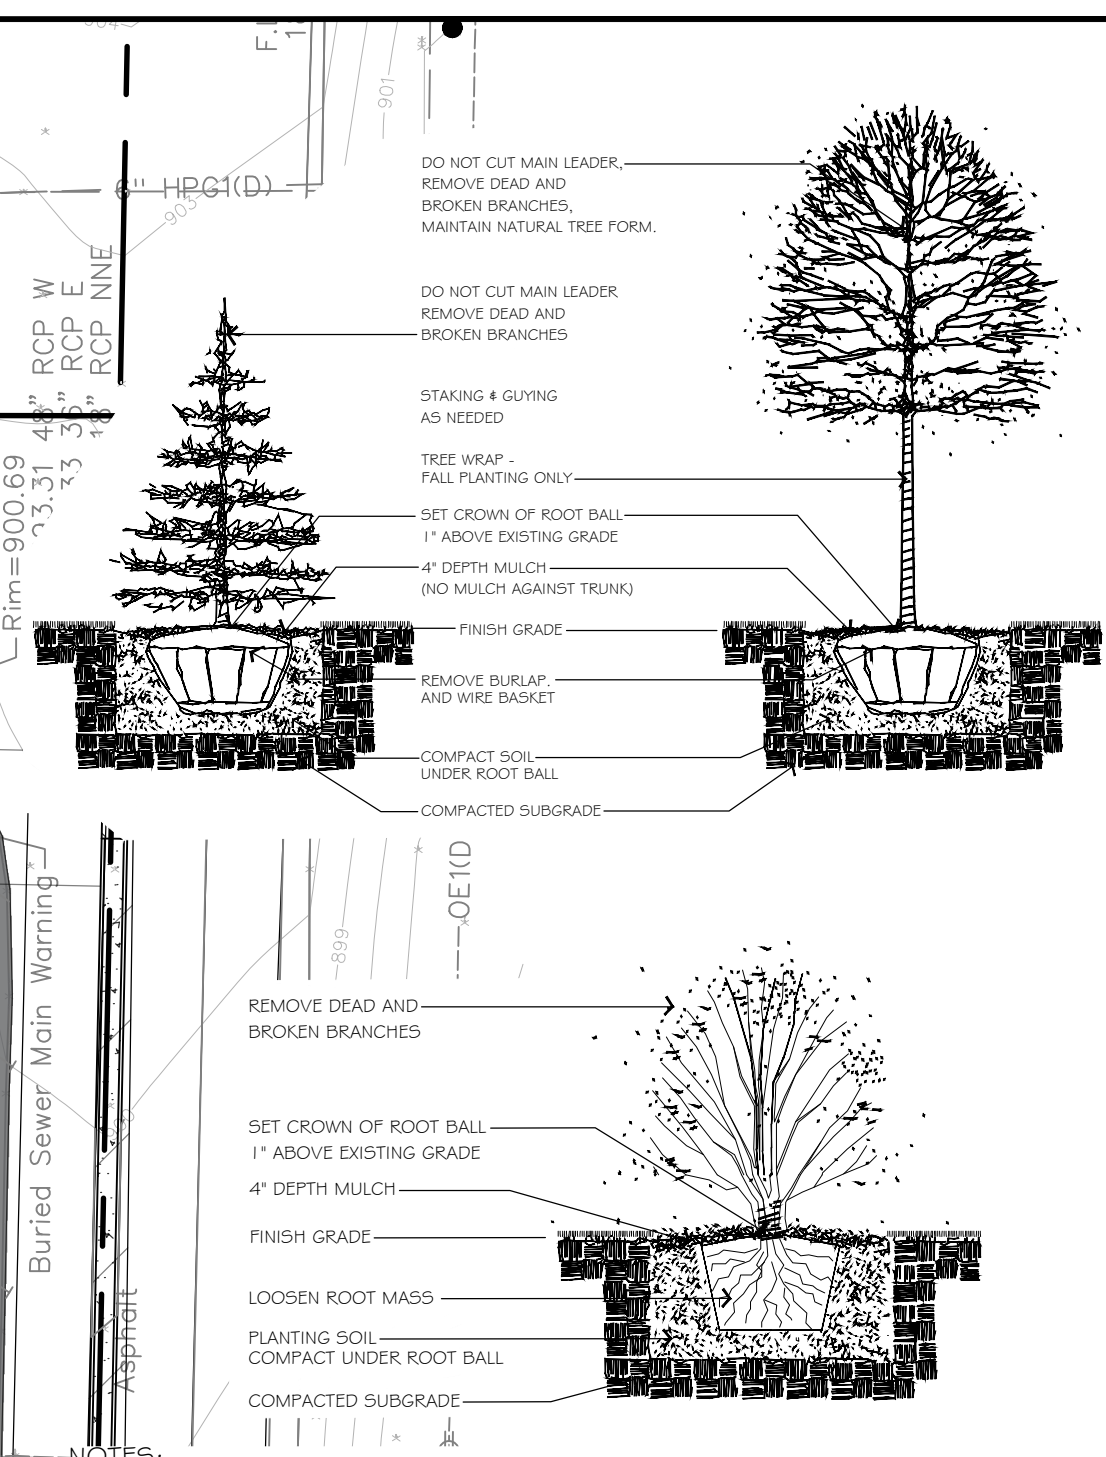
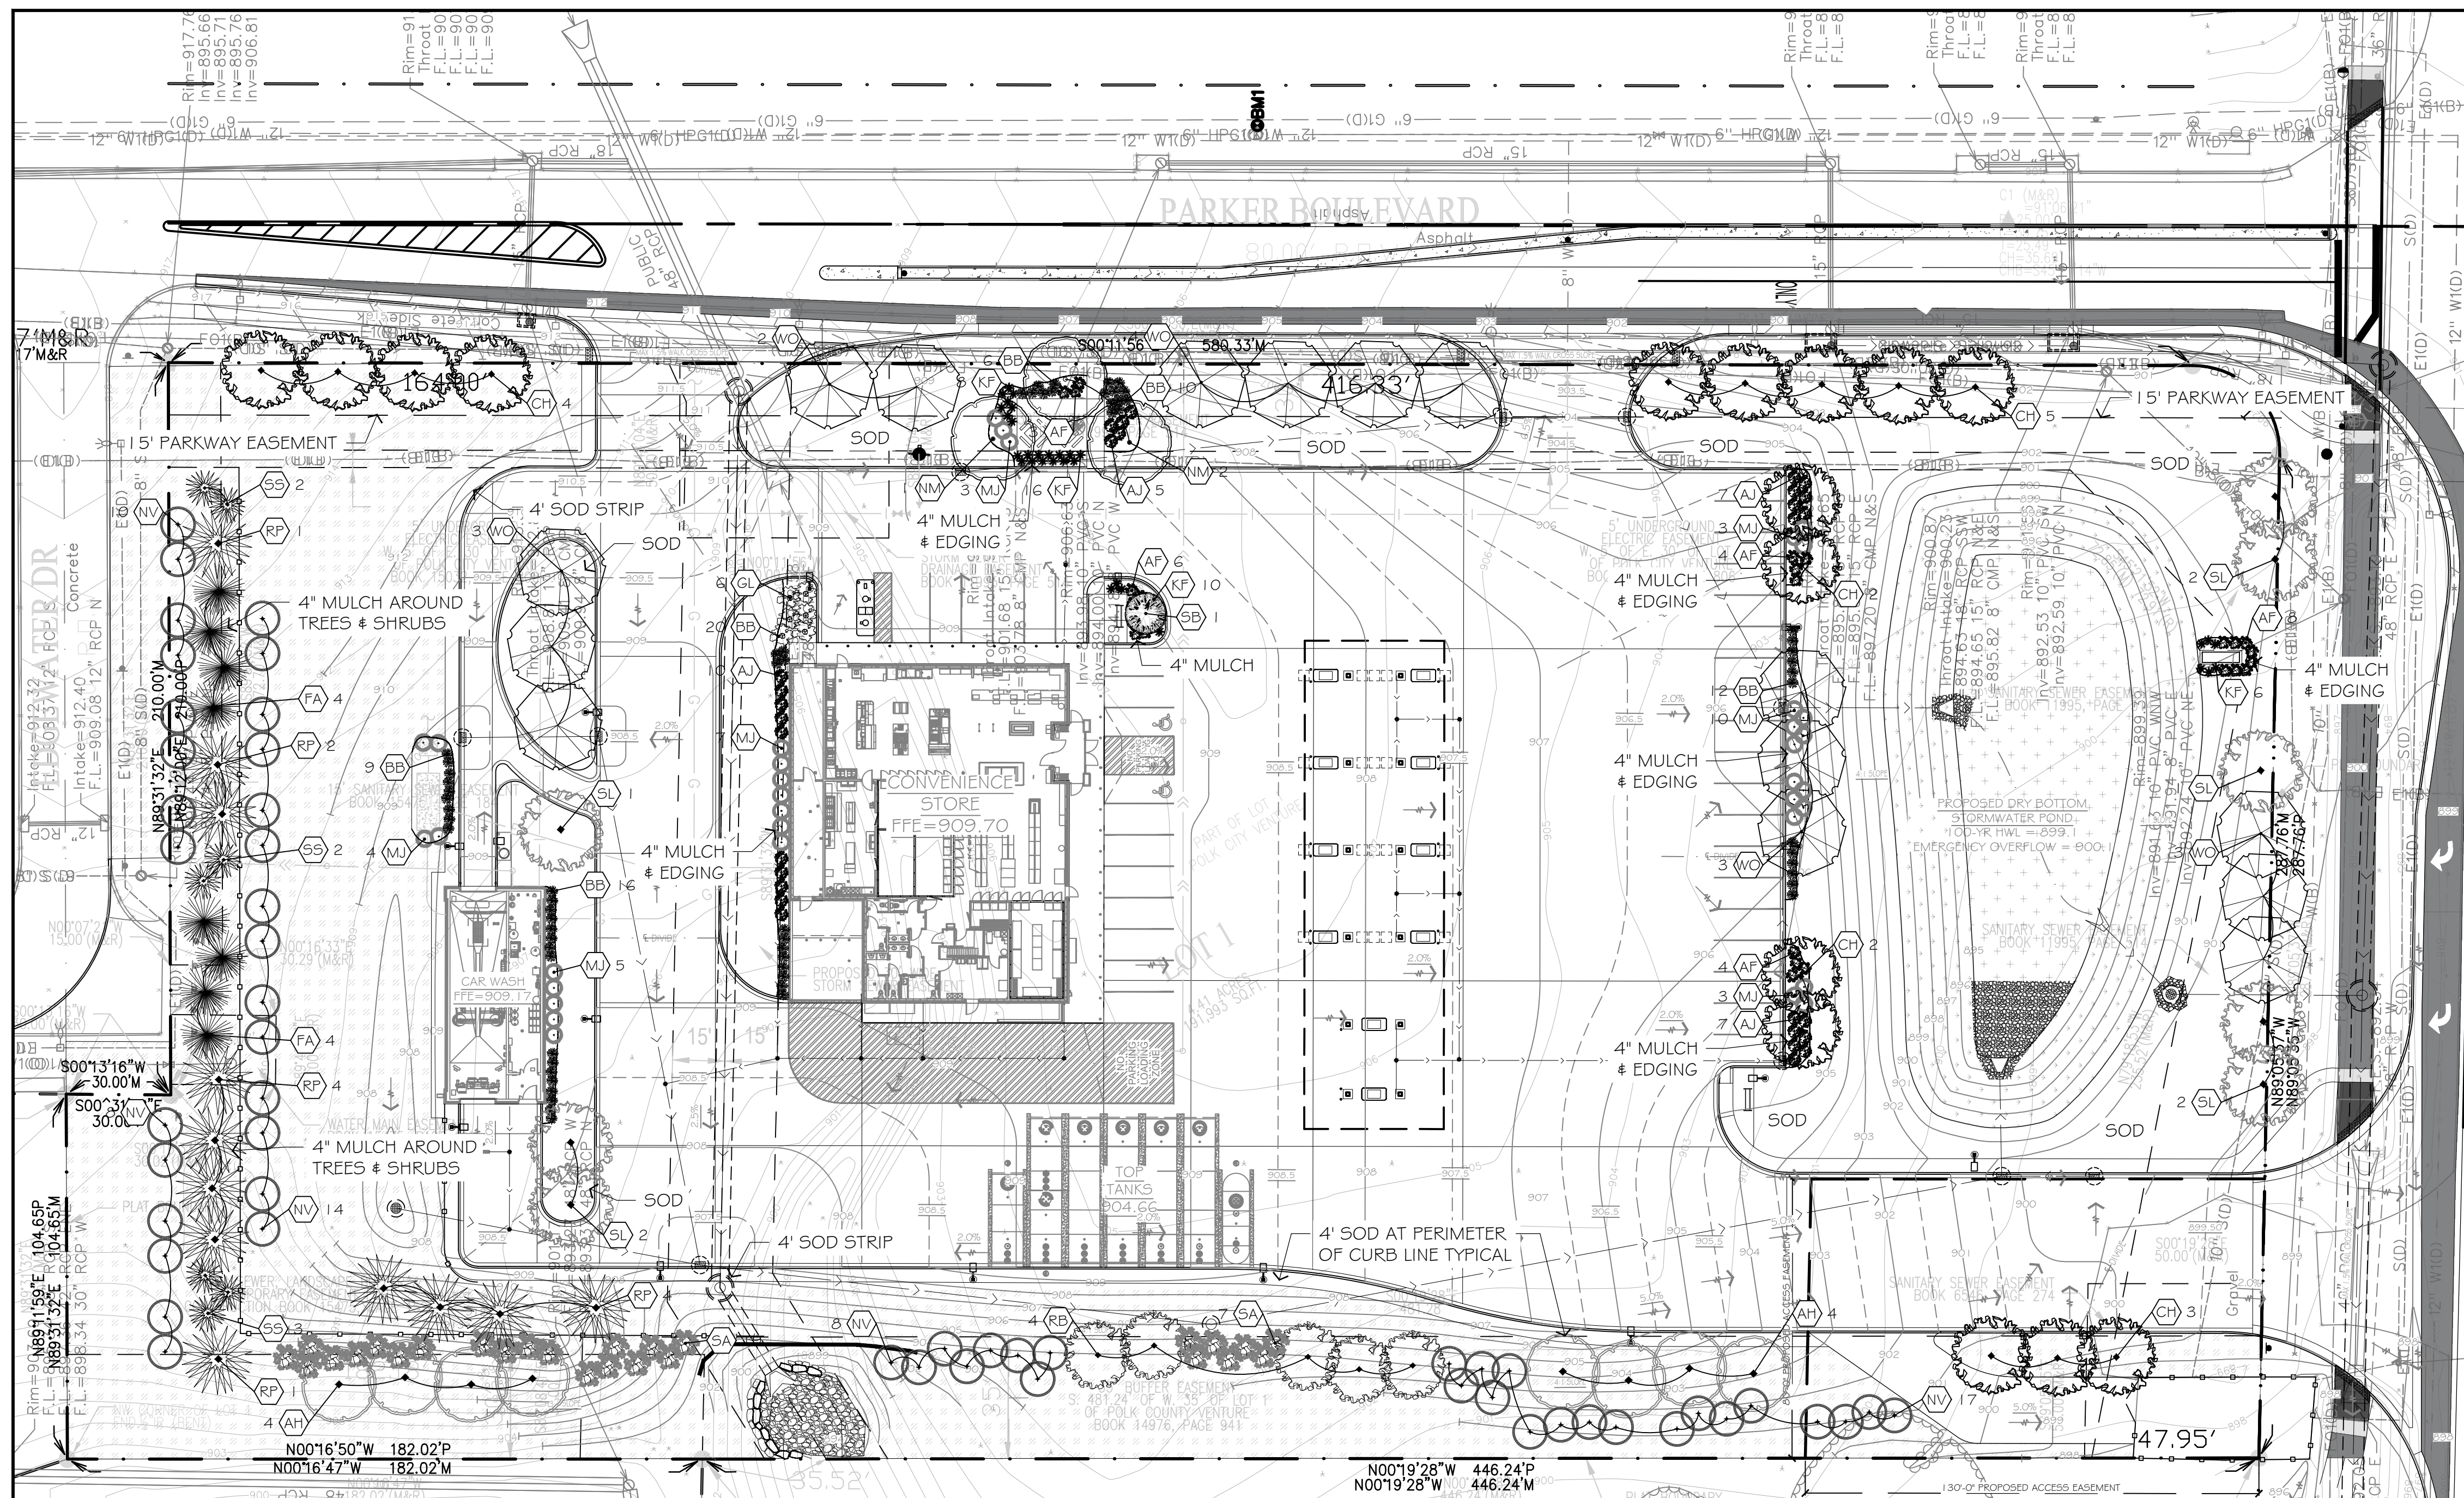
Professional Engineer Seal for Robert J. Mueller, License No. 00377, State of Wisconsin, dated June 2020.

SUDAS SITE PLAN DETAILS
CONVENIENCE STORE 1089
POLK CITY, IOWA

NO.	DATE	DESCRIPTION
1	1/20/19	SUBMITTAL COMMENTS
2	2/20/19	SITE SHIFT APPROACHES
3	3/20/19	SUBMITTAL COMMENTS
4	3/20/19	CANOPY LAYOUT
5	3/20/19	COMMENTS
6	3/20/19	SIGN LOCATION
7	3/20/19	COMMENTS
8	3/20/19	COMMENTS


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PROJ. NO.: 191089
DATE: 26JULY2019
SHEET: **SP7**

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NOTES:

- CONTRACTOR SHALL OBTAIN ALL NECESSARY PERMITS FOR PLANTING IN ALL R.O.W.
- LANDSCAPE CONTRACTOR SHALL VERIFY ALL UTILITIES WHICH MAY AFFECT HIS WORK
- LANDSCAPE CONTRACTOR SHALL COORDINATE HIS WORK WITH OTHERS AT SITE AND COMPLETE HIS WORK PER OWNERS CONSTRUCTION SCHEDULE.
- ALL PLANT MATERIALS SHALL BE GUARANTEED ONE (1) FULL YEAR UPON TOTAL COMPLETION AND ACCEPTANCE BY OWNER, WITH ONE TIME REPLACEMENT AT APPROPRIATE TIME OR UPON REQUEST OF OWNER.
- REPLACEMENT TOPSOIL SHALL BE CLEAN, FREE OF STONES, WEEDS, AND OTHER UNDESIRABLE DEBRIS.
- PLANTING SOIL MIX (INCIDENTAL COST ITEM)
 - MIX 1 LB. 5-20-20 COMMERCIAL FERTILIZER PER CU. YD. TOPSOIL
 - THOROUGHLY MIX 1-PART SAND AND 1-PART PEAT MOSS WITH 5-PARTS FERTILIZER AND TOP SOIL.
- USE PLANTING SOIL AT ALL LOCATIONS PER DETAILS THIS SHEET.
- LANDSCAPE CONTRACTOR SHALL VERIFY TOPSOIL DEPTH AND NOTIFY OWNER OF ANY DEFICIENCY.
- SOD SHALL BE CULTURED WITH PREDOMINANTLY KENTUCKY BLUEGRASS SEED OF RECENT DISEASE RESISTANT INTRODUCTIONS. NO GUARANTEE ON SOD EXCEPT ANY SOD NOT SATISFACTORY AT TIME OF COMPLETION INSPECTION SHALL BE PROMPTLY REPLACED PRIOR TO COMPLETION OF JOB. STAKE SOD ON SLOPES 3:1 AND GREATER.
- WHERE EXISTING CONCRETE/ ASPHALT AREAS ARE TO BE REPLACED WITH LANDSCAPING, PROVISIONS SHOULD BE TAKEN TO COORDINATE EXCAVATION OF SUBSOIL TO A DEPTH OF 2' WITH GRADING CONTRACTOR. REPLACE WITH COMPACTED TOPSOIL. ALL AREAS TO BE LANDSCAPED AND SODDED SHALL BE GRADED SMOOTH AND EVEN.
- LANDSCAPE CONTRACTOR IS RESPONSIBLE FOR SODDING ALL AREAS WHICH ARE DISTURBED BY CONSTRUCTION INCLUDING ALL R.O.W. AND ADJACENT PROPERTIES.
- LANDSCAPE CONTRACTOR IS RESPONSIBLE FOR PROVIDING BLANKET ON ALL SEEDED AREAS THAT ARE SLOPED. MULCH APPLICATION FOR ALL OTHER SEEDED AREAS SHALL BE EITHER HYDROMULCH OR DISKED STRAW DEPENDING ON SEED TYPE, APPLICATION, AND OWNER REQUEST.
- LANDSCAPE CONTRACTOR TO INSTALL VALLEY VIEW, "BLACK DIAMOND" EDGING AROUND ALL PLANTING BEDS AS SHOWN ON THIS PLAN.
- ALL MULCH TO BE FINELY SHREDDED HARDWOOD ORGANIC BARK MULCH. NO DYED MULCHES, INSTALL 4" DEPTH. NO FILTER FABRIC BENEATH ORGANIC MULCHES, NO EDGING AROUND ALL TREES OUTSIDE SHRUB BEDS.
- IF SPECIFIED, ALL GRAVEL MULCH SHALL BE 1" DIA. WASHED "RIVER ROCK". INSTALL 4" DEPTH WITH APPROVED WEED FABRIC BARRIER IF INDICATED PLAN.
- LANDSCAPE CONTRACTOR IS RESPONSIBLE FOR IRRIGATION SYSTEM INSTALLATION PER SHEET 11. DESIGN SHALL BE APPROVED BY OWNER PRIOR TO INSTALLATION. IRRIGATION DESIGN SHOULD ENCOMPASS ALL LANDSCAPE AREAS WITH SOD AND/OR PLANTINGS, FROM CURB TO CURB. R.O.W. SHOULD BE IRRIGATED FROM SPRINKLER HEADS LOCATED WITHIN PROPERTY BOUNDARY. CARE SHOULD BE TAKEN IN VICINITY OF ALL WALKS AND DRIVES TO MINIMIZE OVER SPRAY. COORDINATE INSTALLATION OF ALL PVC SLEEVE UNDER DRIVE AREAS WITH GENERAL CONTRACTOR.
- LANDSCAPE CONTRACTOR SHALL CLEAN ALL PAVEMENT AREAS AFTER ALL LANDSCAPE INSTALLATION IS COMPLETE AND ACCEPTED BY OWNER AND DAILY AS DEEMED NECESSARY BY THE CITY.
- GENERAL CONTRACTOR TO SWEEP PAVEMENT AREAS PRIOR TO TURN OVER TO OWNER.



811
Know what's below.
Call before you dig.

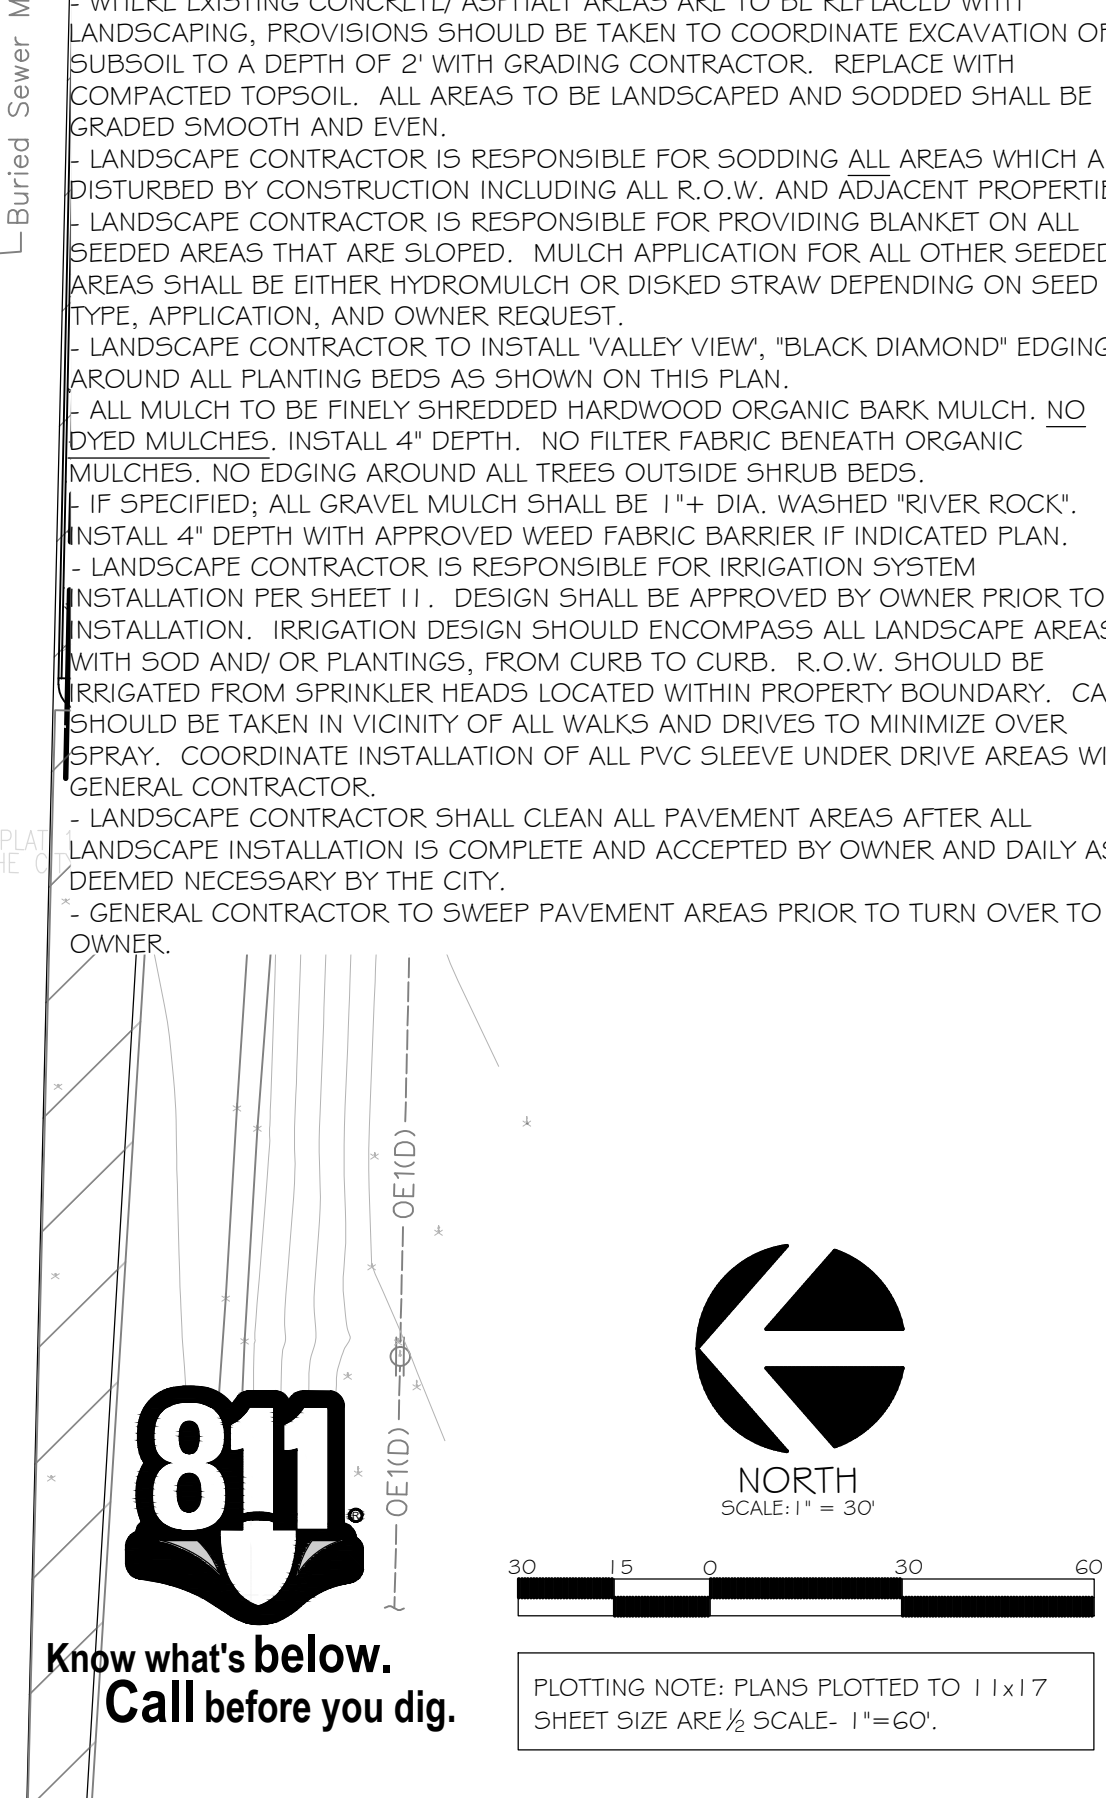PLOTTING NOTE: PLANS PLOTTED TO 11x17 SHEET SIZE ARE 1/2" SCALE. 1"=60'.

PLANT MATERIAL			HEIGHT X WIDTH	SHRUBS				
OVERSTORY TREES				NV 57	#5 CONT	pot	MANHATTAN VIBURNUM <i>Viburnum lentago</i>	15' x 10'
CH	16	2.5' CAL.	60' x 50'	SA 26	#5 CONT	pot	SWAMP AZALEA <i>Rhododendron viscosum (L.) Torr.</i>	5' x 7'
WO	15	2.5' CAL.	50' x 50'	AJ 26	#3 CONT	pot	AMBER JUBILEE NINEBARK <i>Physocarpus opulifolius 'Jefant'</i>	5' x 4'
NM	3	2.5' CAL.	50' x 35'	MJ 35	#3 CONT	pot	MANEY JUNIPER <i>Juniperus chinensis 'Maney'</i>	4' x 5'
SL	6	2.5' CAL.	50' x 30'	AF 17	#3 CONT	pot	ARCTIC FIRE DOGWOOD <i>Cornus stolonifera 'Farrow'</i>	4' x 4'
AH	8	2.5' CAL.	50' x 30'	GL 6	#3 CONT	pot	GRO-LOW FRAGRANT SUMAC <i>Rhus aromatica 'Gro-Low'</i>	2' x 7'
UNDERSTORY TREES				BB 61	#1 CONT	pot	BIG BLUESTEM <i>Andropogon gerardi</i>	5' x 6'
SB	1	1.5' CAL.	40' x 30'	KF 32	#1 CONT	pot	KARL FORESTER FEATHER REED GRASS <i>Calamagrostis x acutiflora 'Karl Forester'</i>	4' x 30'
EVERGREEN TREES				FALL SEEDING IS PREFERABLE (AUG. 20 TO OCT. 20). SPRING SEEDING SHOULD BE BETWEEN MARCH 15-MAY 15. NO SUMMER SEEDING.				
RP	12	10' HT	20' x 15'	+	617 SY		IADOT, WETLAND GRASS SEED MIXTURE (OR APPROVED EQUAL). PROVIDE EROSION CONTROL BLANKET ON SIDE SLOPES.	
FA	8	5' HT	50' x 40'	+	1,104 SY		IADOT, NATIVE GRASS AND WILDFLOWER SEED MIXTURE (OR APPROVED EQUAL). PROVIDE EROSION CONTROL BLANKET ON SIDE SLOPES.	
SS	7	6' HT	25' x 10'		5,656 SY		BLUE GRASS MIX. SEE SPECS FOR MULCHING INFORMATION.	
				EDGING --- LF				
				MULCH --- CF				
				SOD --- SY				

LANDSCAPE REQUIREMENTS:

- ZONE: C2
- 15% GREENSPACE REQUIRED
- 191,942 TOTAL SF = 28,791 GREENSPACE SF REQUIRED
- 98,704 PROVIDED

20 TREES REQUIRED # 60 SHRUBS REQUIRED
20 PROVIDED # 177 PROVIDED

-VEHICLE PAVEMENT AREA x 20% TOTAL SF / 700 = 22 TREES
76,947 SF x .20 = 15,390 / 700 = 22 TREES
23 PROVIDED

PARKER BLVD TREES: 15 REQUIRED/PROVIDED
W BRIDGE STREET TREES: 8 REQUIRED/PROVIDED


WEST PROPERTY BUFFER YARD
TYPE B
WIDTH = >25 FT
628 FT = 13 TREES # 51 SHRUBS REQUIRED
13 # 51 PROVIDED

Kwik Trip

Kwik Star

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LANDSCAPE PLAN

CONVENIENCE STORE 1089

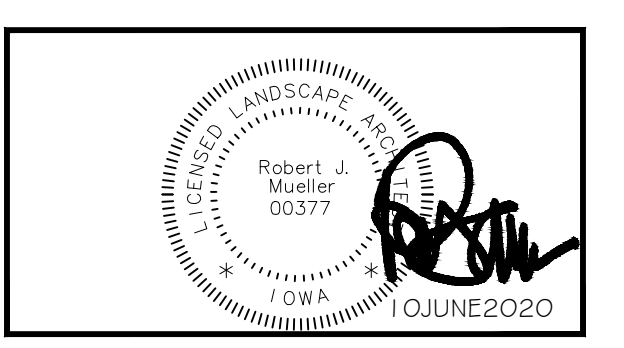POLK CITY, IOWA


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23	05/19/21	COMMENTS
22	11/19/21	SITE SHIFT APPROACHES
02	01/20/22	SUBMITTAL
23	01/20/22	CANOPY LAYOUT
25	02/20/22	COMMENTS
1	01/20/22	SIGN LOCATION
03	01/20/22	COMMENTS
10	01/20/22	9/10/2020 COMMENTS

DRAWN BY _____ SCALE _____ GRAPHIC

PROJ. NO. _____ DATE 1/9/2020

DATE 26 JULY 2019

SHEET **L1**

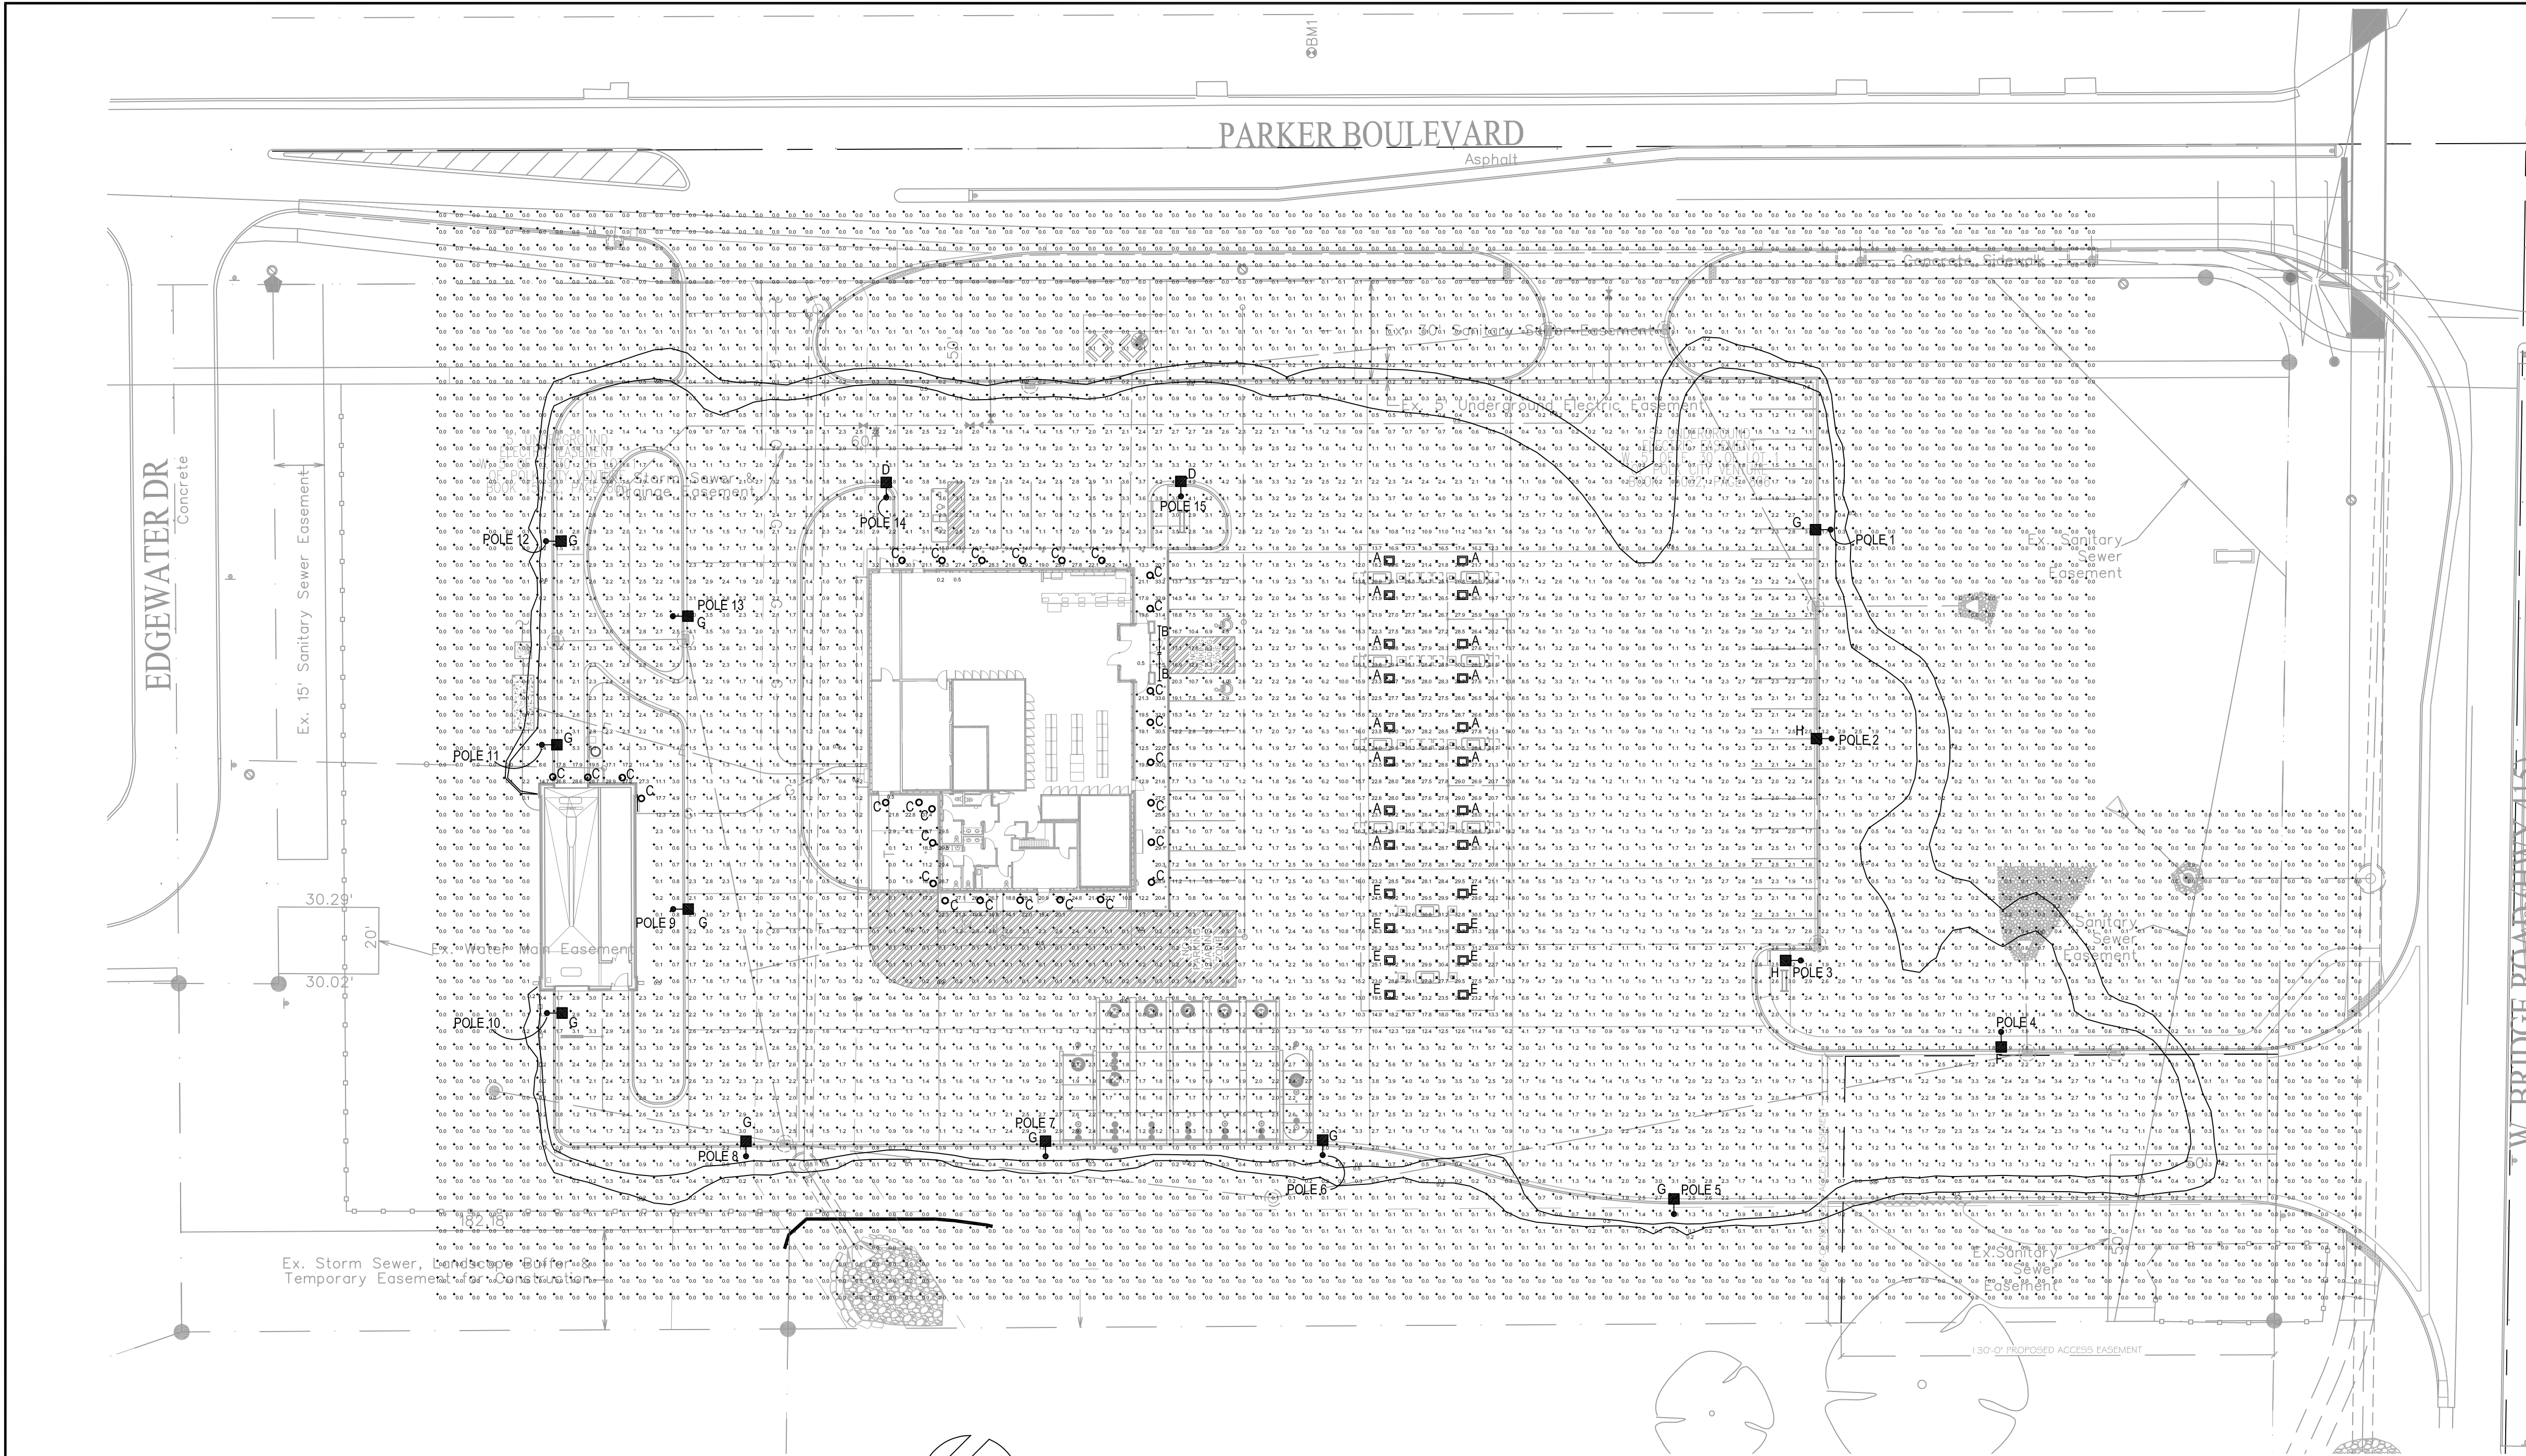

W. BRIDGE RD. HWY 414

PHOTOMETRIC SITE PLAN
SCALE: 1" = 30'-0"

Statistics						
Description	Symbol	Avg	Max	Min	Max/Min	Avg/Min
FUEL CANOPY	X	28.1 fc	33.7 fc	12.3 fc	2.71	2.11
OVERALL	+	2.4 fc	37.4 fc	0.0 fc	N/A	N/A

NOTE:
FOOTCANDLE LEVELS SHOWN ARE CALCULATED AT GRADE LEVEL.

FIXTURE QUANTITIES

- A - 16
- B - 2
- C - 28
- D - 2
- E - 8
- F - 1
- G - 10
- H - 2


PROVIDE (15) 16' POLES.

FIXTURE SYMBOLS:

- A & E LED LIGHT MOUNTED UNDER FUEL CANOPY
- B LED STRIP LIGHT MOUNTED IN GABLE
- C RECESSED LED DOWNLIGHT
- D, F, G & H POLE MOUNTED LED FIXTURE

FIXTURE TYPES:

- A - LSI LIGHTING: CRUS-SC4-ED-HO-50-UE-DIM-WHT
FIXTURE IS SHOWN DIMMED AT 50%
MOUNTED UNDER GAS PORTION OF FUEL CANOPY
- B - LED STRIP LIGHT MOUNTED IN GABLE
LITHONIA - TZL1N4L6
- C - RECESSED LED DOWNLIGHT
GOTHAM EVO-35/30-8AR-WD-120-TRW
- D - LSI LIGHTING: SLM-LED-9L-SIL-2-UNV-50-70CRI-WHT
- E - LSI LIGHTING: CRUS-SC4-ED-HO-50-UE-DIM-BLK
FIXTURE IS SHOWN DIMMED AT 50%
MOUNTED UNDER DIESEL PORTION OF FUEL CANOPY
- F - LSI LIGHTING: SLM-LED-9L-SIL-3-UNV-50-70CRI-WHT
- G - LSI LIGHTING: SLM-LED-9L-SIL-FT-UNV-50-70CRI-WHT-L
- H - LSI LIGHTING: SLM-LED-9L-SIL-FT-UNV-50-70CRI-WHT

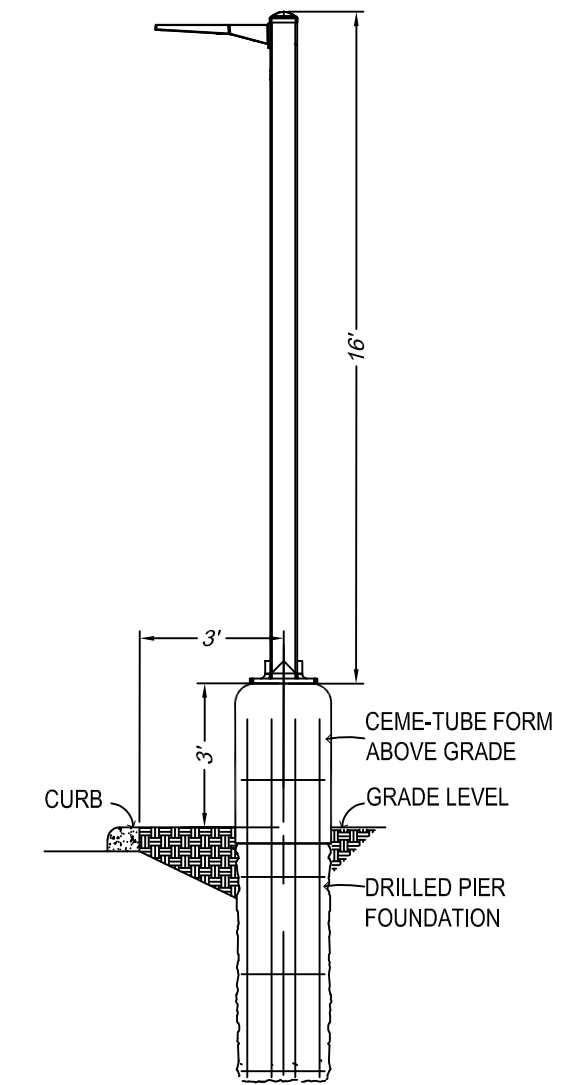


LOT LIGHT ELEVATION DETAIL
NOT TO SCALE

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PHOTOMETRIC SITE PLAN

CONVENIENCE STORE 1089

POLK CITY, IOWA

NO.	DATE	DESCRIPTION
1	10/18/18	SCHEMATIC
2	23/SEP/19	COMMENTS
3	22/NOV/19	SITE SHIFT APPROACHES
4	02/JAN/20	SUBMITTER
5	23/JAN/20	CANOPY LAYOUT
6	25/FEB/20	COMMENTS
7	19/MAR/20	SIGN LOCATION
8	03/JUN/20	COMMENTS
9	10/JUN/20	SUJUNO COMMENTS

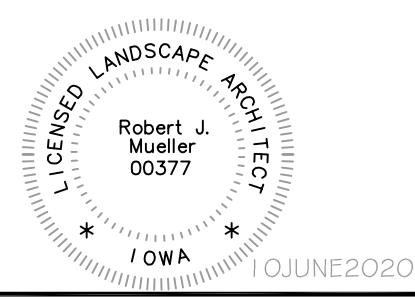DRAWN BY	AMM
SCALE	GRAPHIC
PROJ. NO.	191089
DATE	26/JULY/2019
SHEET	E1

2019-0195.31
GR&EF
275 West Wisconsin Avenue, Suite 300
Milwaukee, WI 53203
414 / 259 1500
414 / 259 0037 fax

INSITES 19-0195.PW-27